

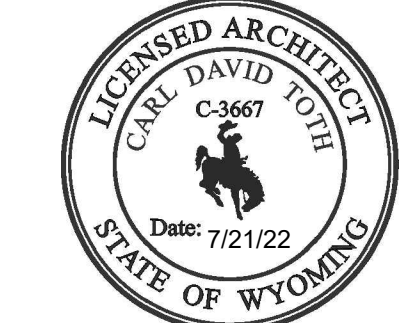
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DATE: 07/21/2022
PROJECT NO.: 22075
CAD PLATFORM: ACA 2023
PLOT REF. NO.: SEE LOWER LEFT
DRAWING SCALE: SEE DRAWING

REVISIONS

MARK	DATE	INIT.	DESCRIPTION

C

PROJECT TITLE

B

CIAD - WYOMING
5 NEZ PERCE DRIVE
CODY, WYOMING 82414

SHEET TITLE
GNRL - COVER

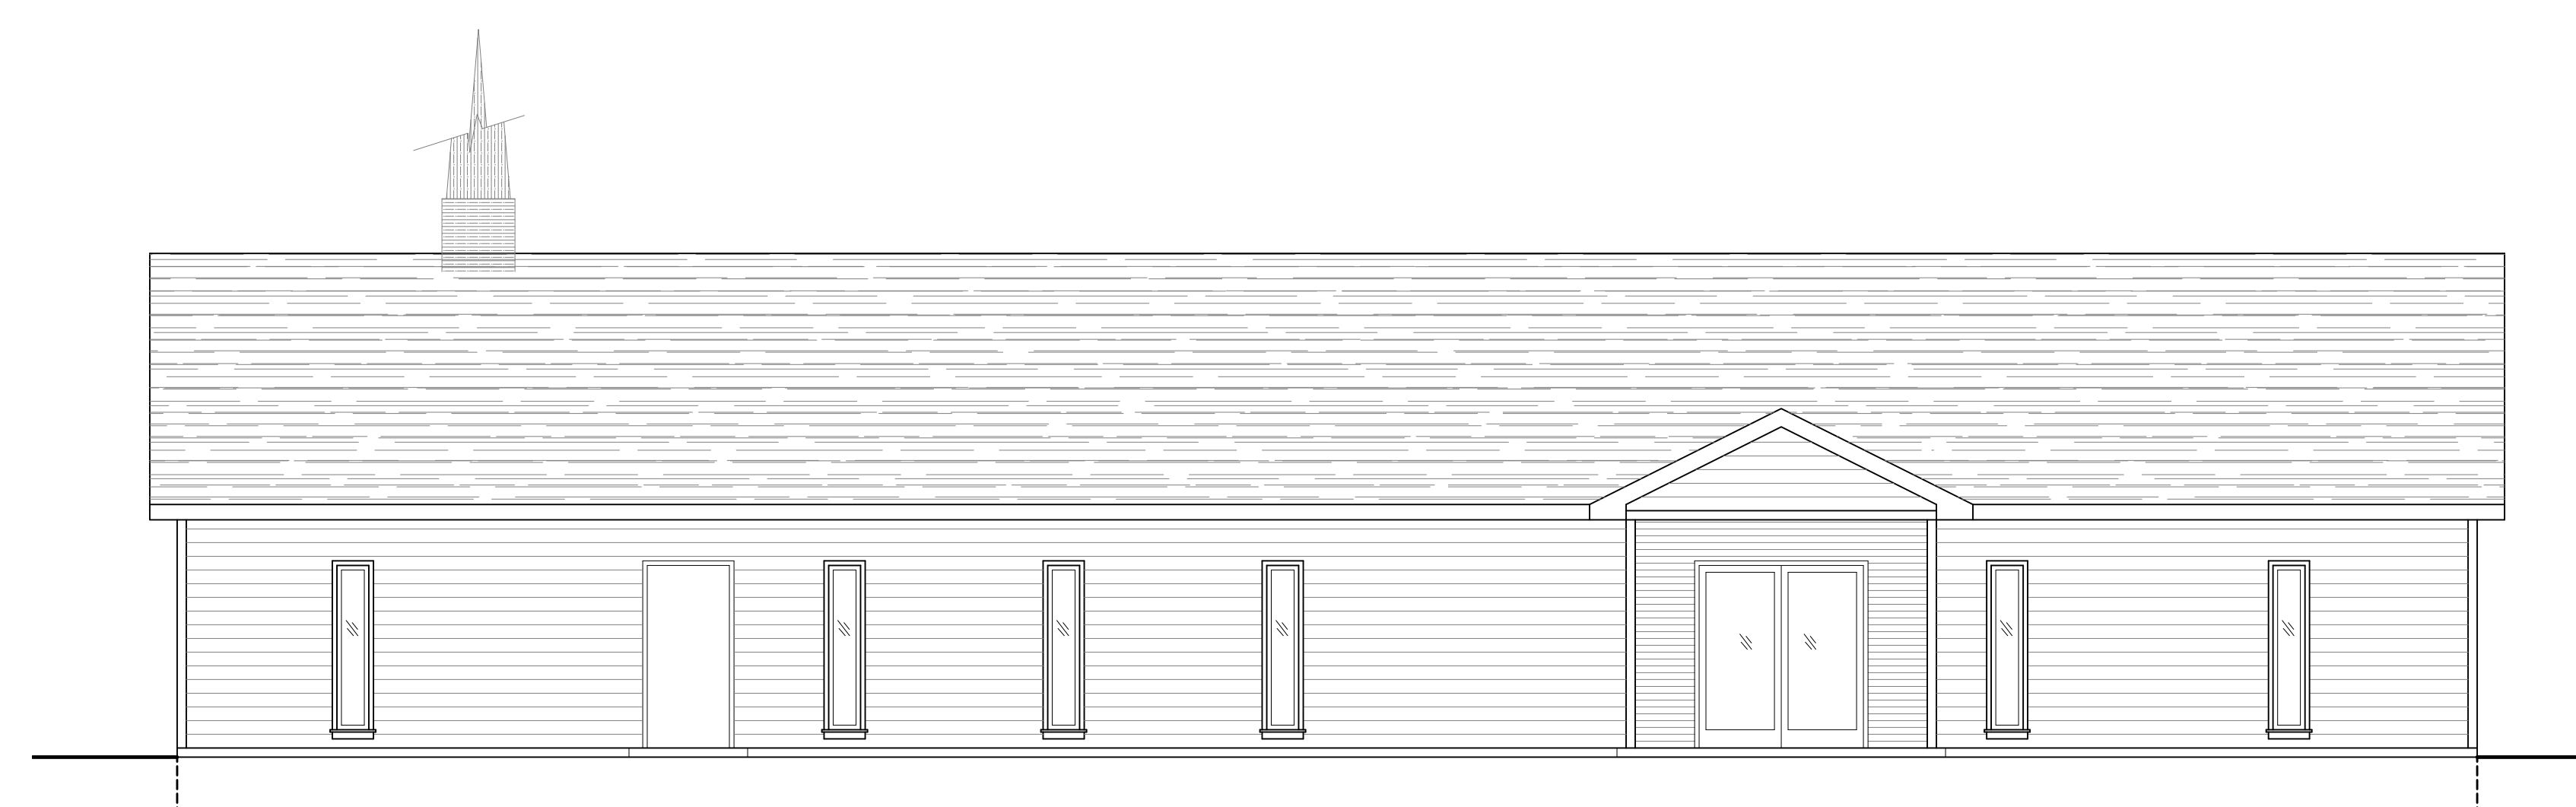
SHEET NUMBER

G101

SHEET: OF:

GENERAL PROJECT NOTES:

- A. ALL CONSTRUCTION SHALL COMPLY WITH APPLICABLE BUILDING CODES AND LOCAL RESTRICTIONS. CONTRACTORS MUST COMPLY WITH CONTRACTOR REGISTRATION REQUIREMENTS OF ALL GOVERNING AUTHORITIES. THE GENERAL BUILDING PERMITS SHALL BE PAID FOR BY THE GENERAL CONTRACTOR. ALL OTHER PERMITS SHALL BE SECURED AND PAID FOR BY THE SUBCONTRACTOR DIRECTLY RESPONSIBLE. ALL REQUIRED CITY, COUNTY AND/OR STATE LICENSES SHALL BE ACQUIRED AND PAID FOR BY THE INDIVIDUAL SUBCONTRACTOR.
- B. APPROVED PLANS SHALL BE KEPT IN A PLAN BOX AND SHALL NOT BE USED BY WORKMEN. ALL CONSTRUCTION SETS SHALL REFLECT SAME INFORMATION. CONTRACTOR SHALL MAINTAIN ONE COMPLETE SET OF PLANS ON THE PREMISES IN GOOD CONDITION AT ALL TIMES. THIS SHALL INCLUDE ALL ADDENDA AND CHANGE ORDERS.
- C. DISCREPANCIES BETWEEN PORTIONS OF THE CONTRACT DOCUMENTS, DRAWINGS AND SPECIFICATIONS ARE NOT INTENDED. THE CONTRACTOR IS TO CLARIFY ANY SUCH DISCREPANCIES WITH THE ARCHITECT PRIOR TO COMMENCING WORK.
- D. STATED DIMENSIONS TAKE PRECEDENCE OVER GRAPHICS, DO NOT SCALE DRAWINGS TO DETERMINE LOCATIONS. THE ARCHITECT SHALL BE NOTIFIED OF ANY SUCH DISCREPANCIES PRIOR TO CONTINUING WITH WORK.
- E. IT SHALL BE THE RESPONSIBILITY OF THE CONTRACTOR TO LOCATE ALL EXISTING UTILITIES AND TO PROTECT THEM FROM DAMAGE. CONTRACTOR SHALL BEAR THE EXPENSE OF REPAIR OR REPLACEMENT OF UTILITIES OR OTHER PROPERTY DAMAGED BY OPERATIONS IN CONJUNCTION WITH THE EXECUTION OF THE WORK.
- F. GENERAL CONTRACTOR TO REFER TO THESE DOCUMENTS AS WELL AS SPECIFICATIONS FOR IDENTIFICATION OF ALL OWNER SUPPLIED ITEMS. ALL ITEMS NOT MARKED AS 'OWNER SUPPLIED' ARE TO BE SUPPLIED BY GENERAL CONTRACTOR. UNLESS NOTED OTHERWISE, ALL ITEMS ARE TO BE INSTALLED BY THE GENERAL CONTRACTOR.
- G. FOR CONSTRUCTION DETAILS NOT SHOWN, USE THE MANUFACTURER'S APPROVED SHOP DRAWINGS/DATA SHEETS IN ACCORDANCE WITH THE PROJECT SPECIFICATIONS.
- H. THE CONTRACTOR SHALL BE RESPONSIBLE FOR THE COMPLETE SECURITY OF THE SITE WHILE JOB IS IN PROGRESS AND UNTIL BUILDING IS OCCUPIED PER THE PROVISIONS OF THE CONTRACT DOCUMENTS.
- I. ALL DEBRIS SHALL BE REMOVED FROM PREMISES AND ALL AREAS SHALL BE LEFT IN A CLEAN (BROOM) CONDITION AT ALL TIMES.
- J. CONTRACTOR SHALL TAKE ALL NECESSARY PRECAUTIONS TO ENSURE THE SAFETY OF THE OCCUPANTS AND WORKERS AT ALL TIMES.
- K. CONTRACTOR SHALL PROVIDE TEMPORARY WATER, POWER AND TOILET FACILITIES AS REQUIRED.
- L. IT IS THE INTENT OF THE ARCHITECT THAT THIS WORK BE IN CONFORMANCE WITH ALL REQUIREMENTS OF THE BUILDING AUTHORITIES HAVING JURISDICTION OVER THIS TYPE OF CONSTRUCTION AND OCCUPANCY.
- M. CONTRACTOR SHALL SUPPLY, LOCATE AND BUILD INTO THE WORK ALL INSERTS, ANCHORS, ANGLES, PLATES, OPENINGS, SLEEVES, HANGERS, SLAB DEPRESSIONS AND PITCHES AS MAY BE REQUIRED TO ATTACH AND ACCOMMODATE OTHER WORK.
- N. ALL DETAILS AND SECTIONS SHOWN ON THE DRAWINGS ARE INTENDED TO BE TYPICAL AND SHALL BE CONSTRUED TO APPLY TO ANY SIMILAR SITUATIONS ELSEWHERE IN THE WORK EXCEPT WHERE A DIFFERENT DETAIL IS SHOWN.
- O. IT IS SOLELY THE CONTRACTOR'S RESPONSIBILITY TO DETERMINE ERECTION PROCEDURE AND SEQUENCE TO INSURE THE SAFETY OF THE BUILDING AND ITS COMPONENT PARTS DURING ERECTION.

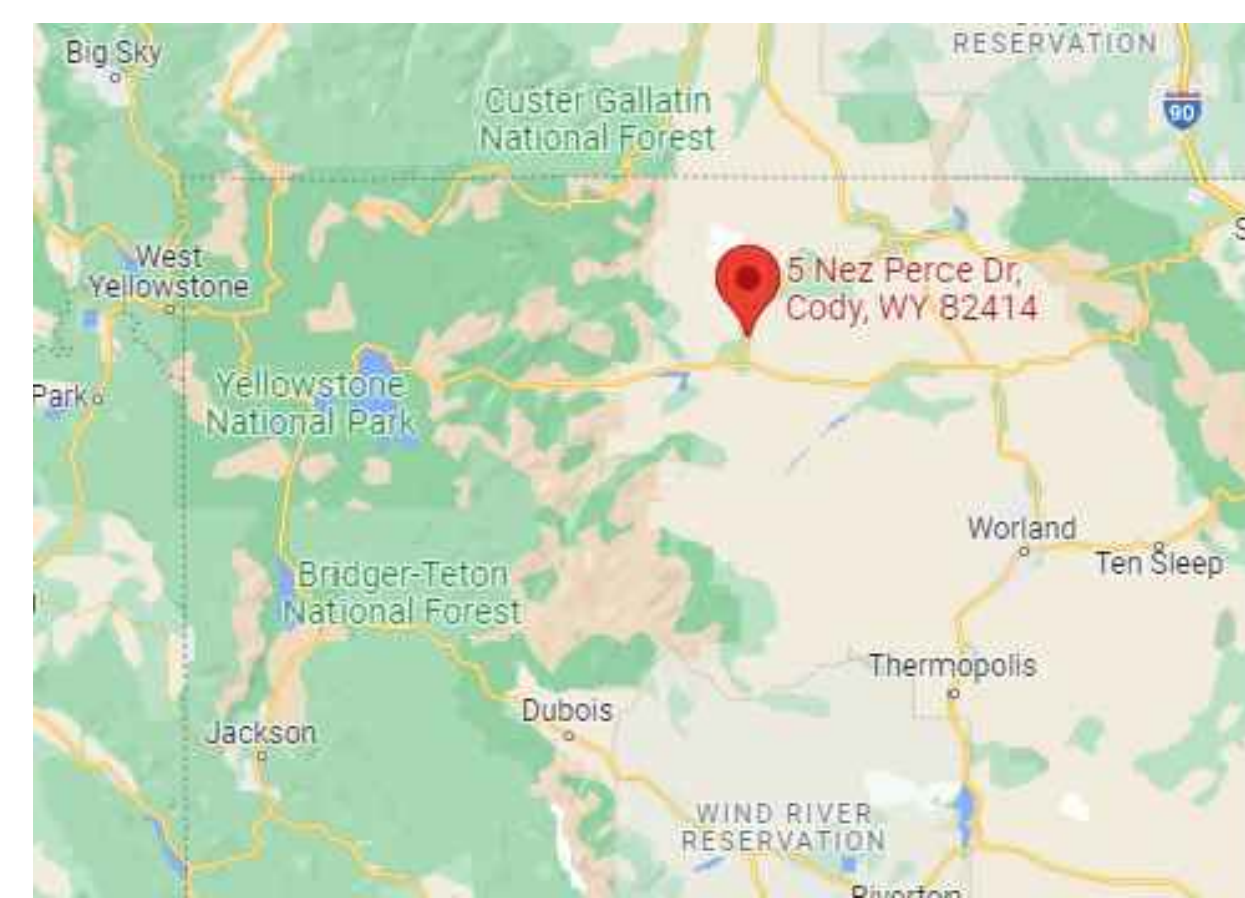


CIAD - CODY, WYOMING

5 NEZ PERCE DRIVE

CODY, WYOMING 82414

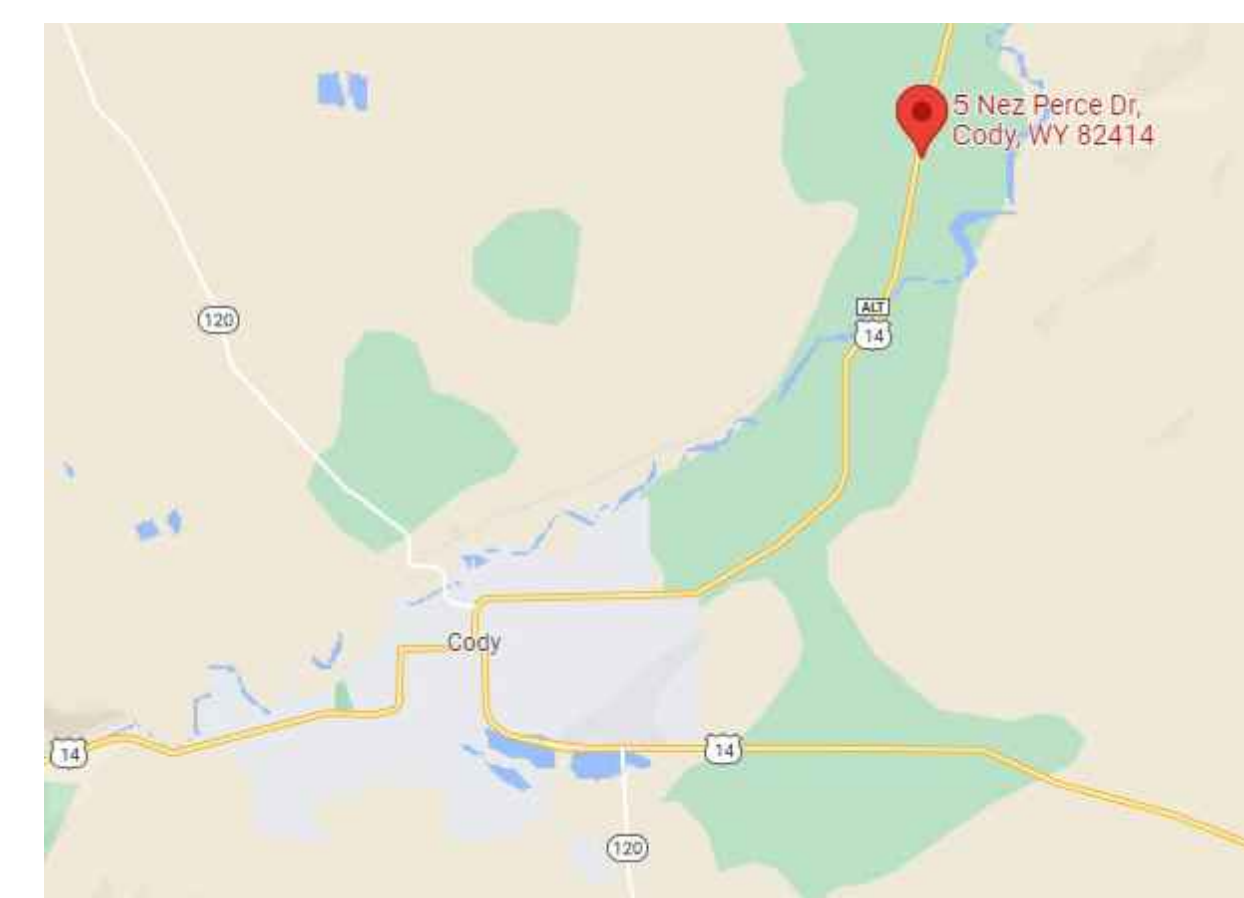
AREA LOCATION MAP:



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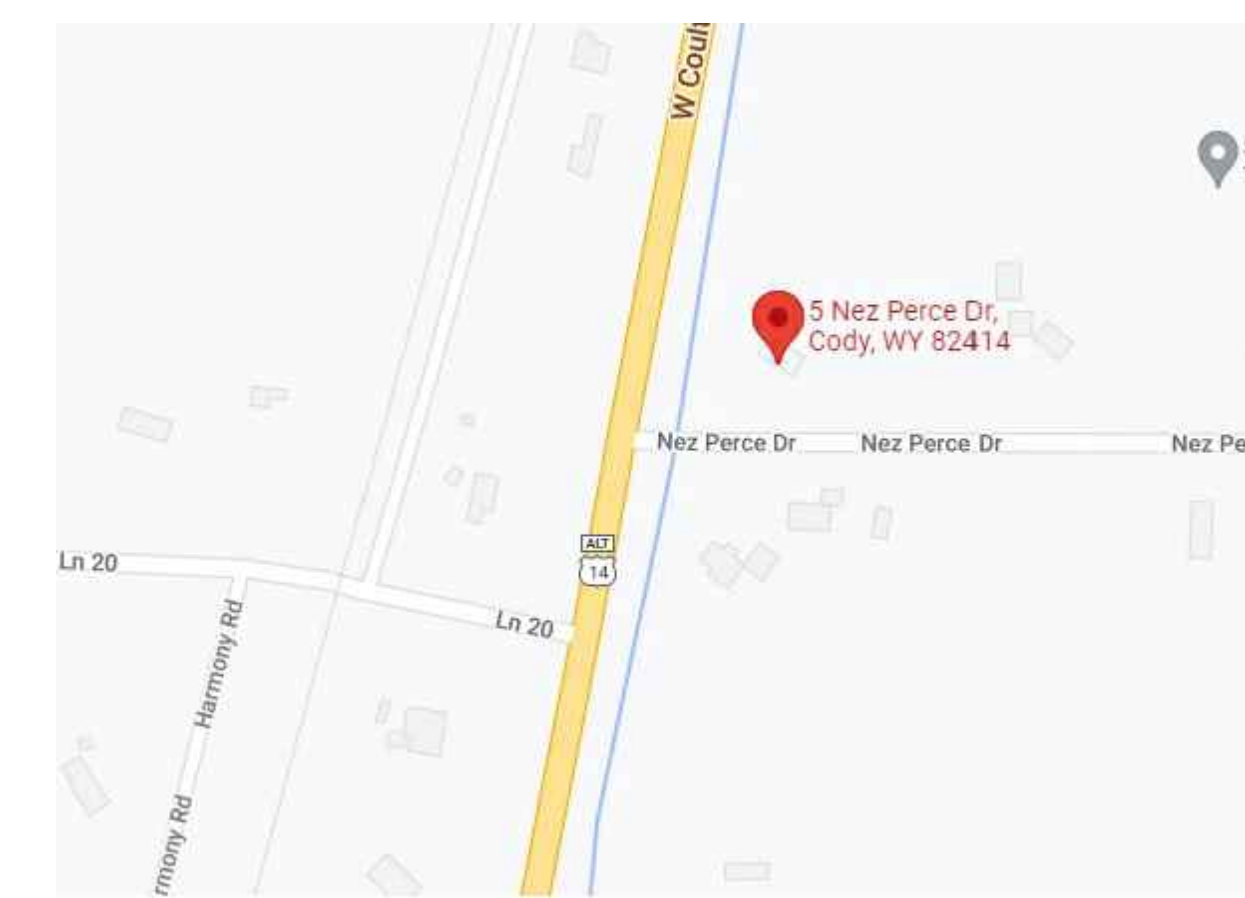
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SITE LOCATION MAP 2:



4

SITE LOCATION MAP 3:



3

2

PROJECT DIRECTORY:

ARCHITECT:
the.
architecture
studio...

5750 CASTLE CREEK PARKWAY N. DRIVE
SUITE 100
INDIANAPOLIS, IN 46250

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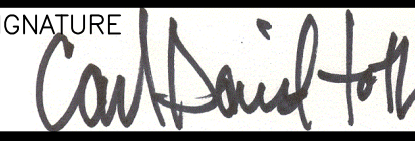
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Sheet List Table

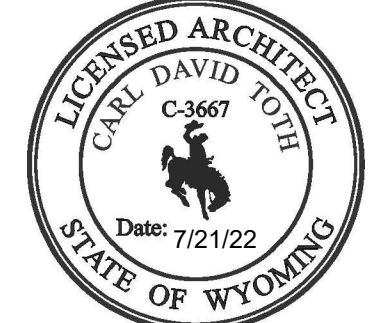
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G111	GNRL - SHEET INDEX
G112	GNRL - ANNOTATIONS
G121	GNRL - ACCESSIBILITY
G122	GNRL - ACCESSIBILITY
G123	GNRL - ACCESSIBILITY
G131	GNRL - CODE ANALYSIS
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S101	STR - NOTES
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 CODY, WYOMING 82414

SHEET TITLE
 GNRL - SHEET
 INDEX

SHEET NUMBER

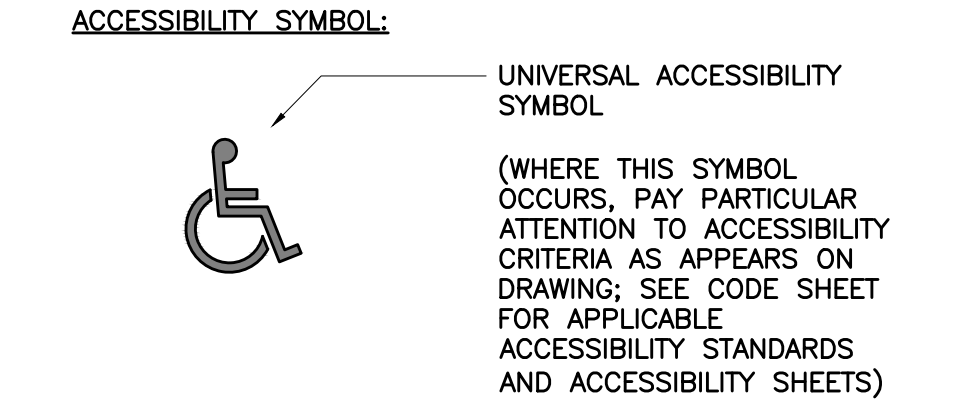
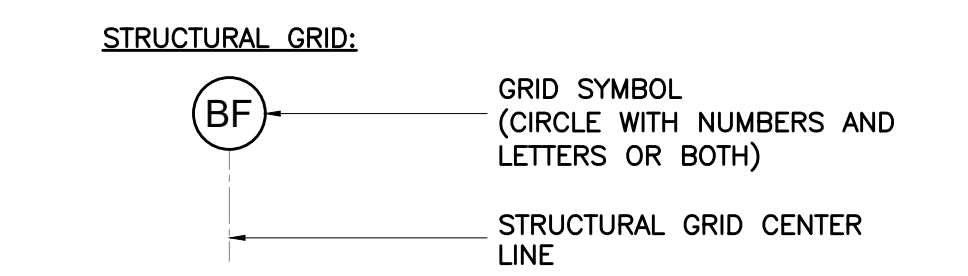
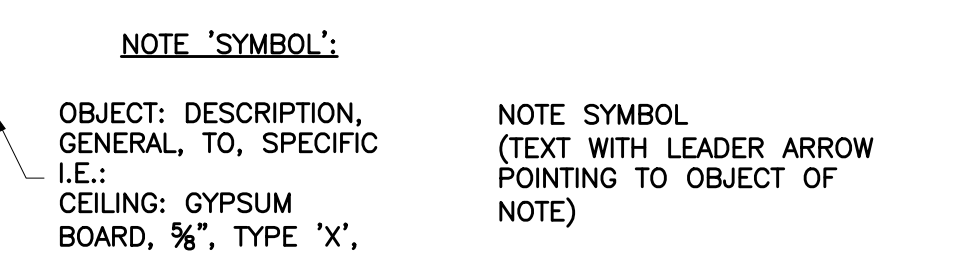
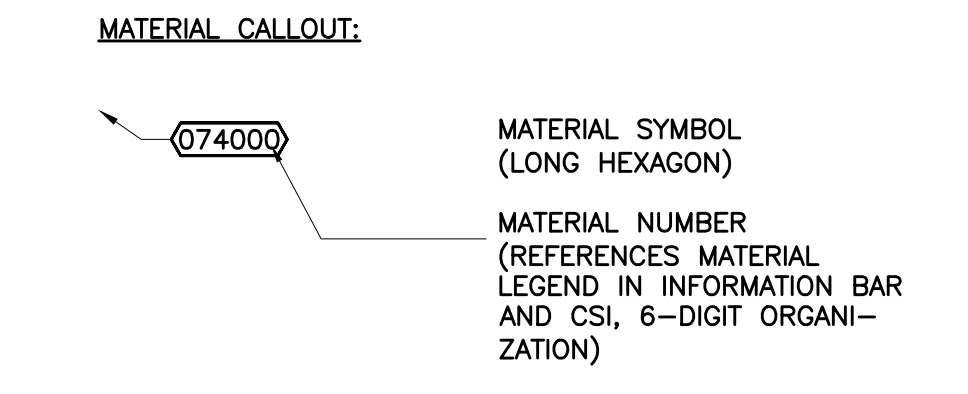
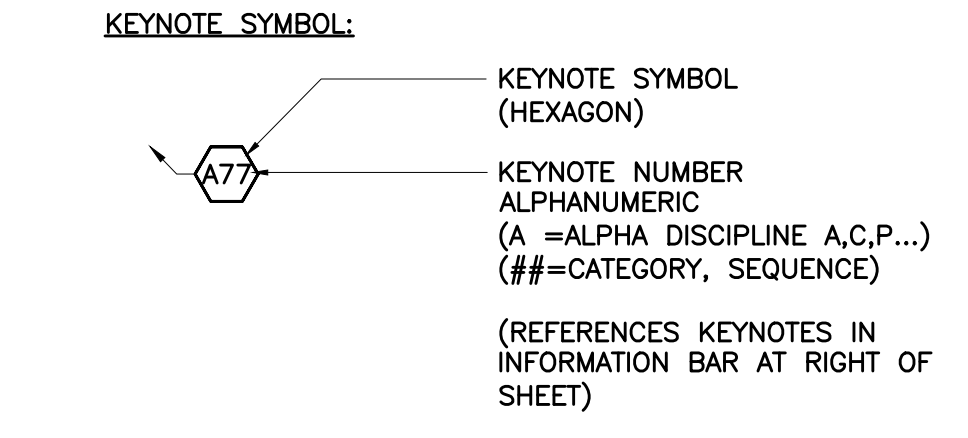
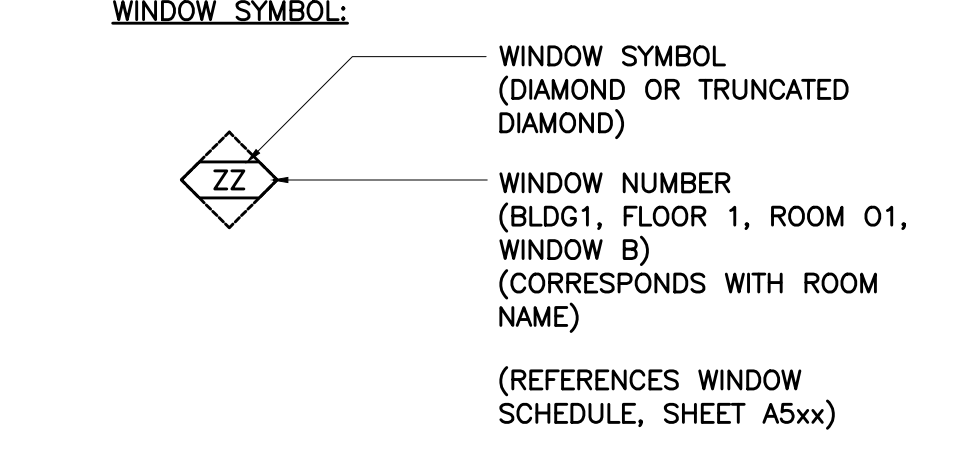
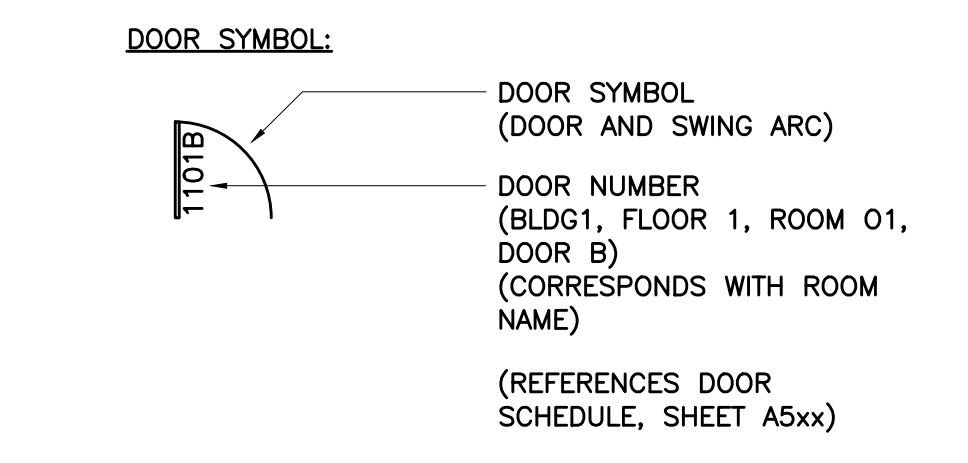
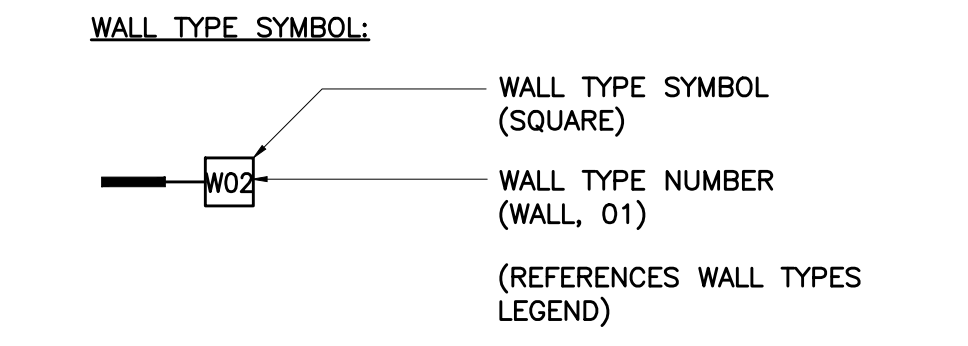
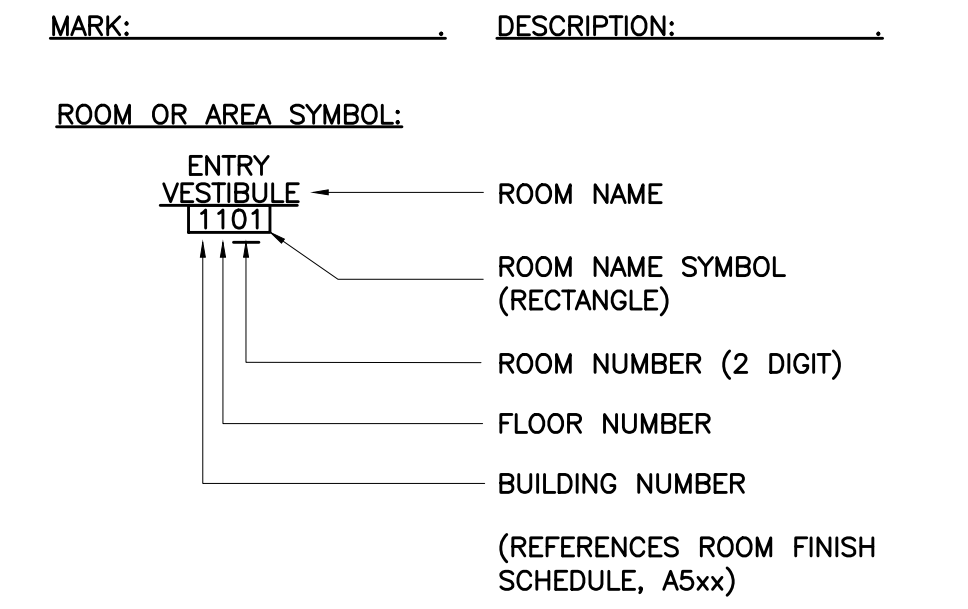
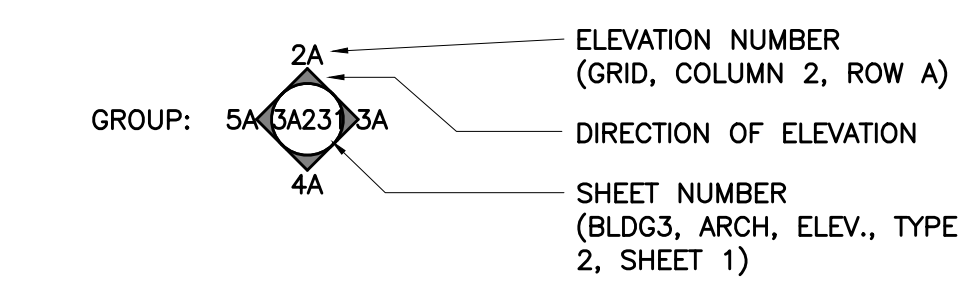
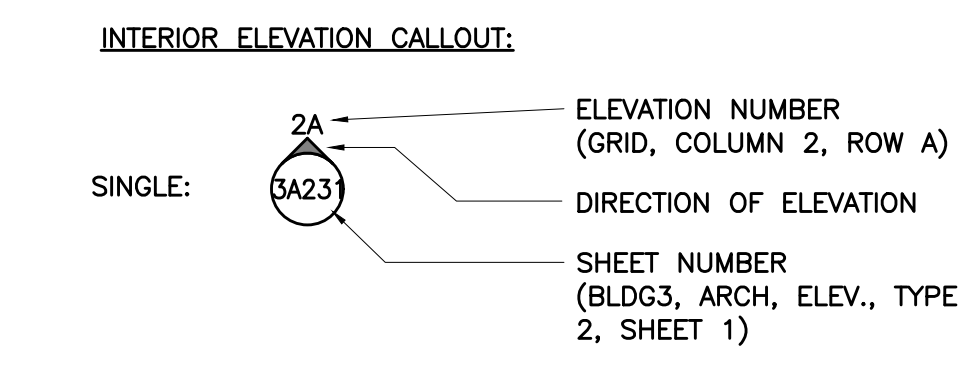
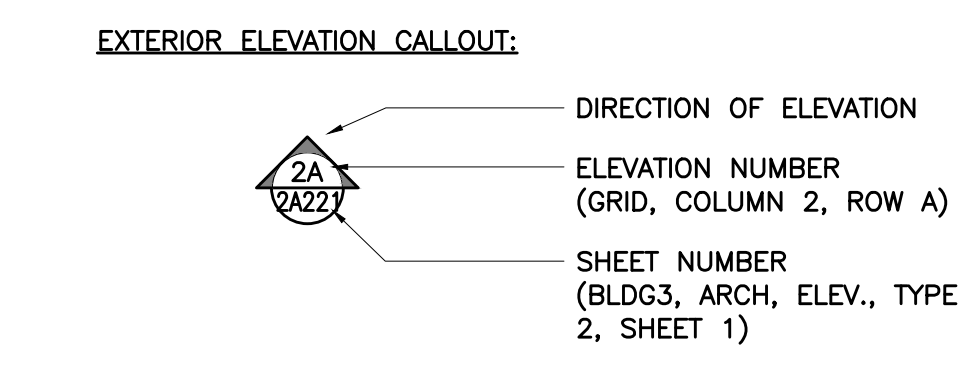
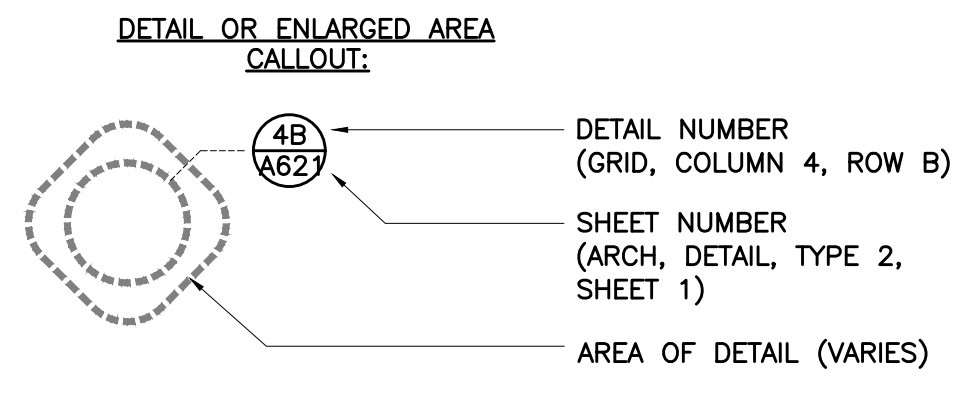
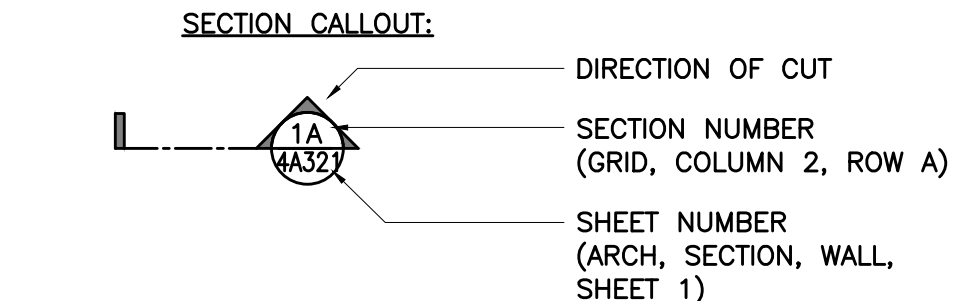
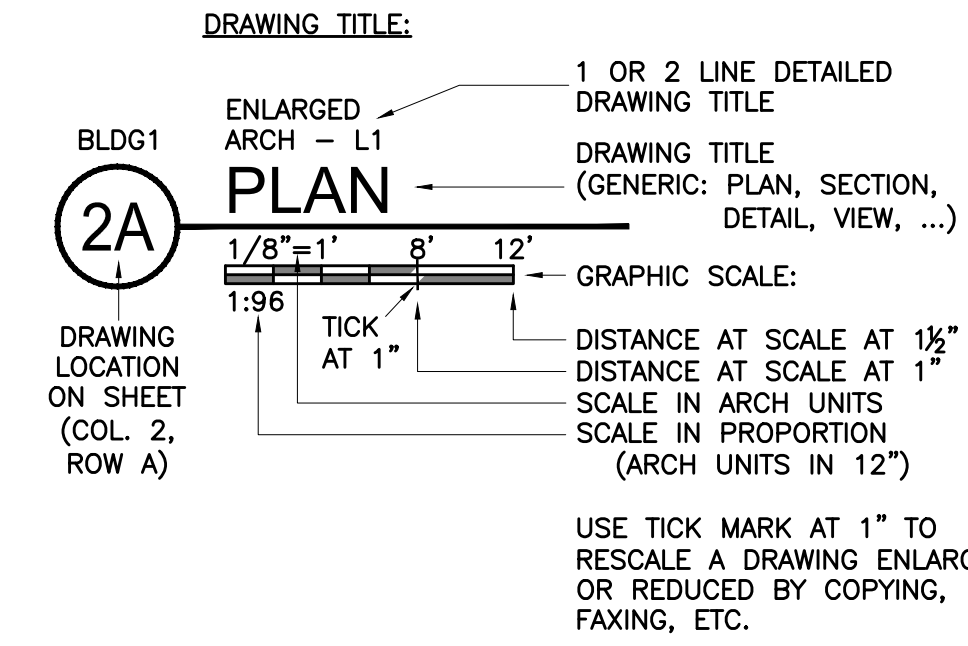
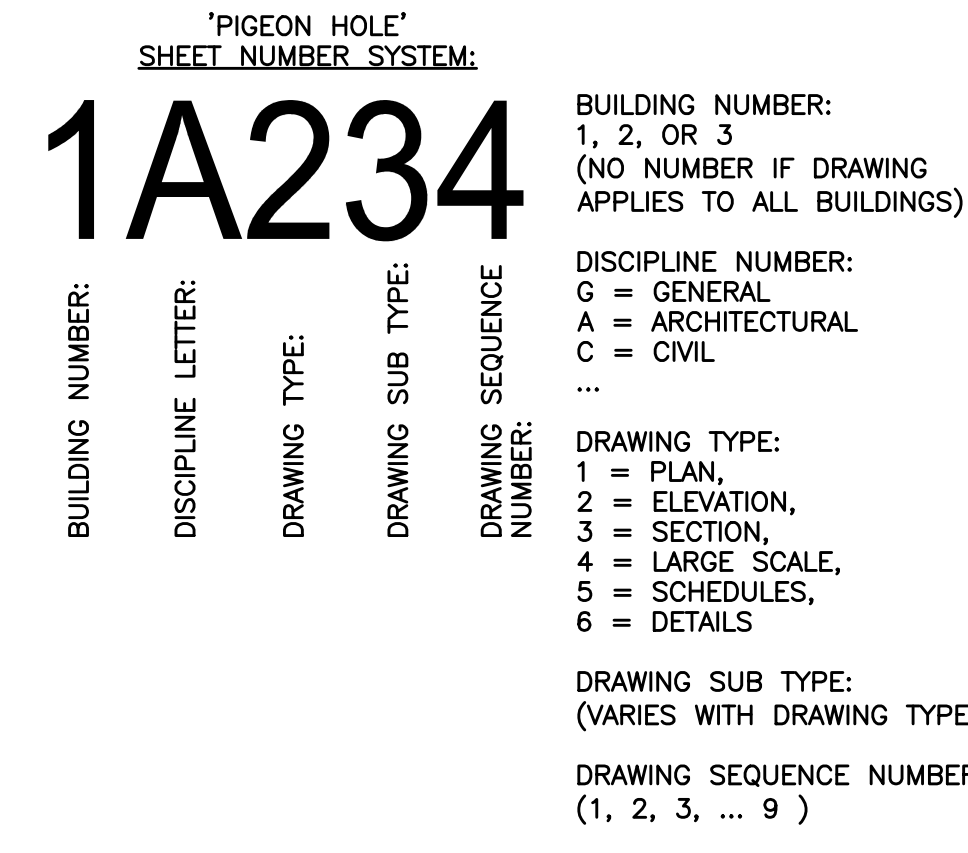
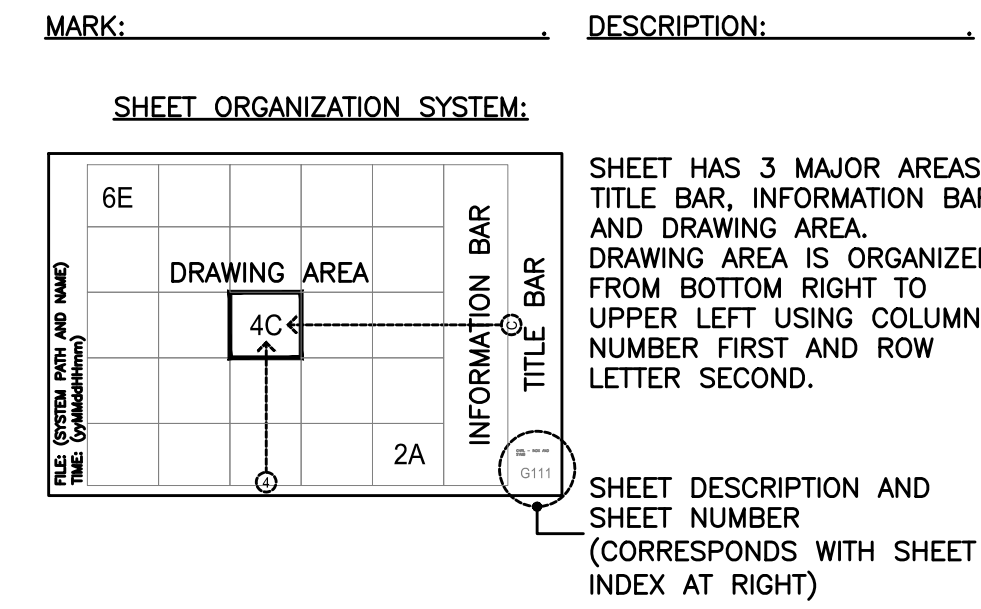
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DEFINITIONS:

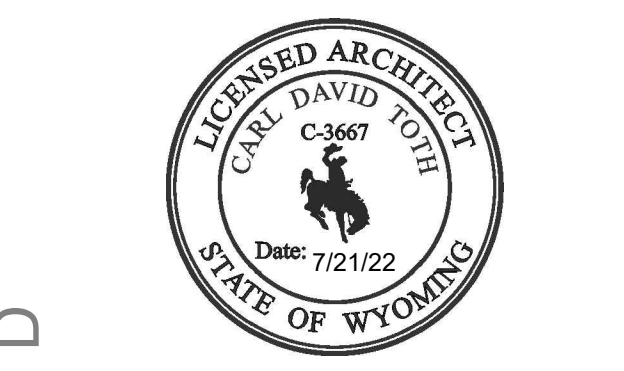
FURNISH: PURCHASE AND DELIVER TO SITE
 INSTALL: PUT IN PLACE
 PROVIDE: FURNISH AND INSTALL
 UNIT IDENTITY:
 EXAMPLE: 1312= BUILDING 1, LEVEL 3, NUMBER 12
 2BR2B= 2 BEDROOM, PLAN 2, ANSI TYPE B

ARCHITECTURAL ANNOTATIONS:



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PROJECT TITLE

CIAD - WYOMING
 5 NEX PERCE DRIVE
 CODY, WYOMING 82414

SHEET TITLE
 GNRL - ANNOTATIONS

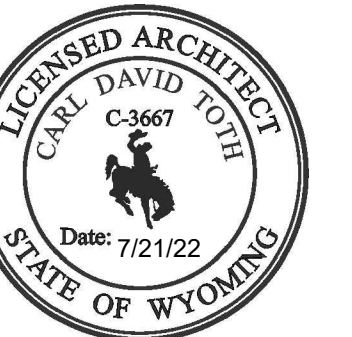
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PROJECT TITLE

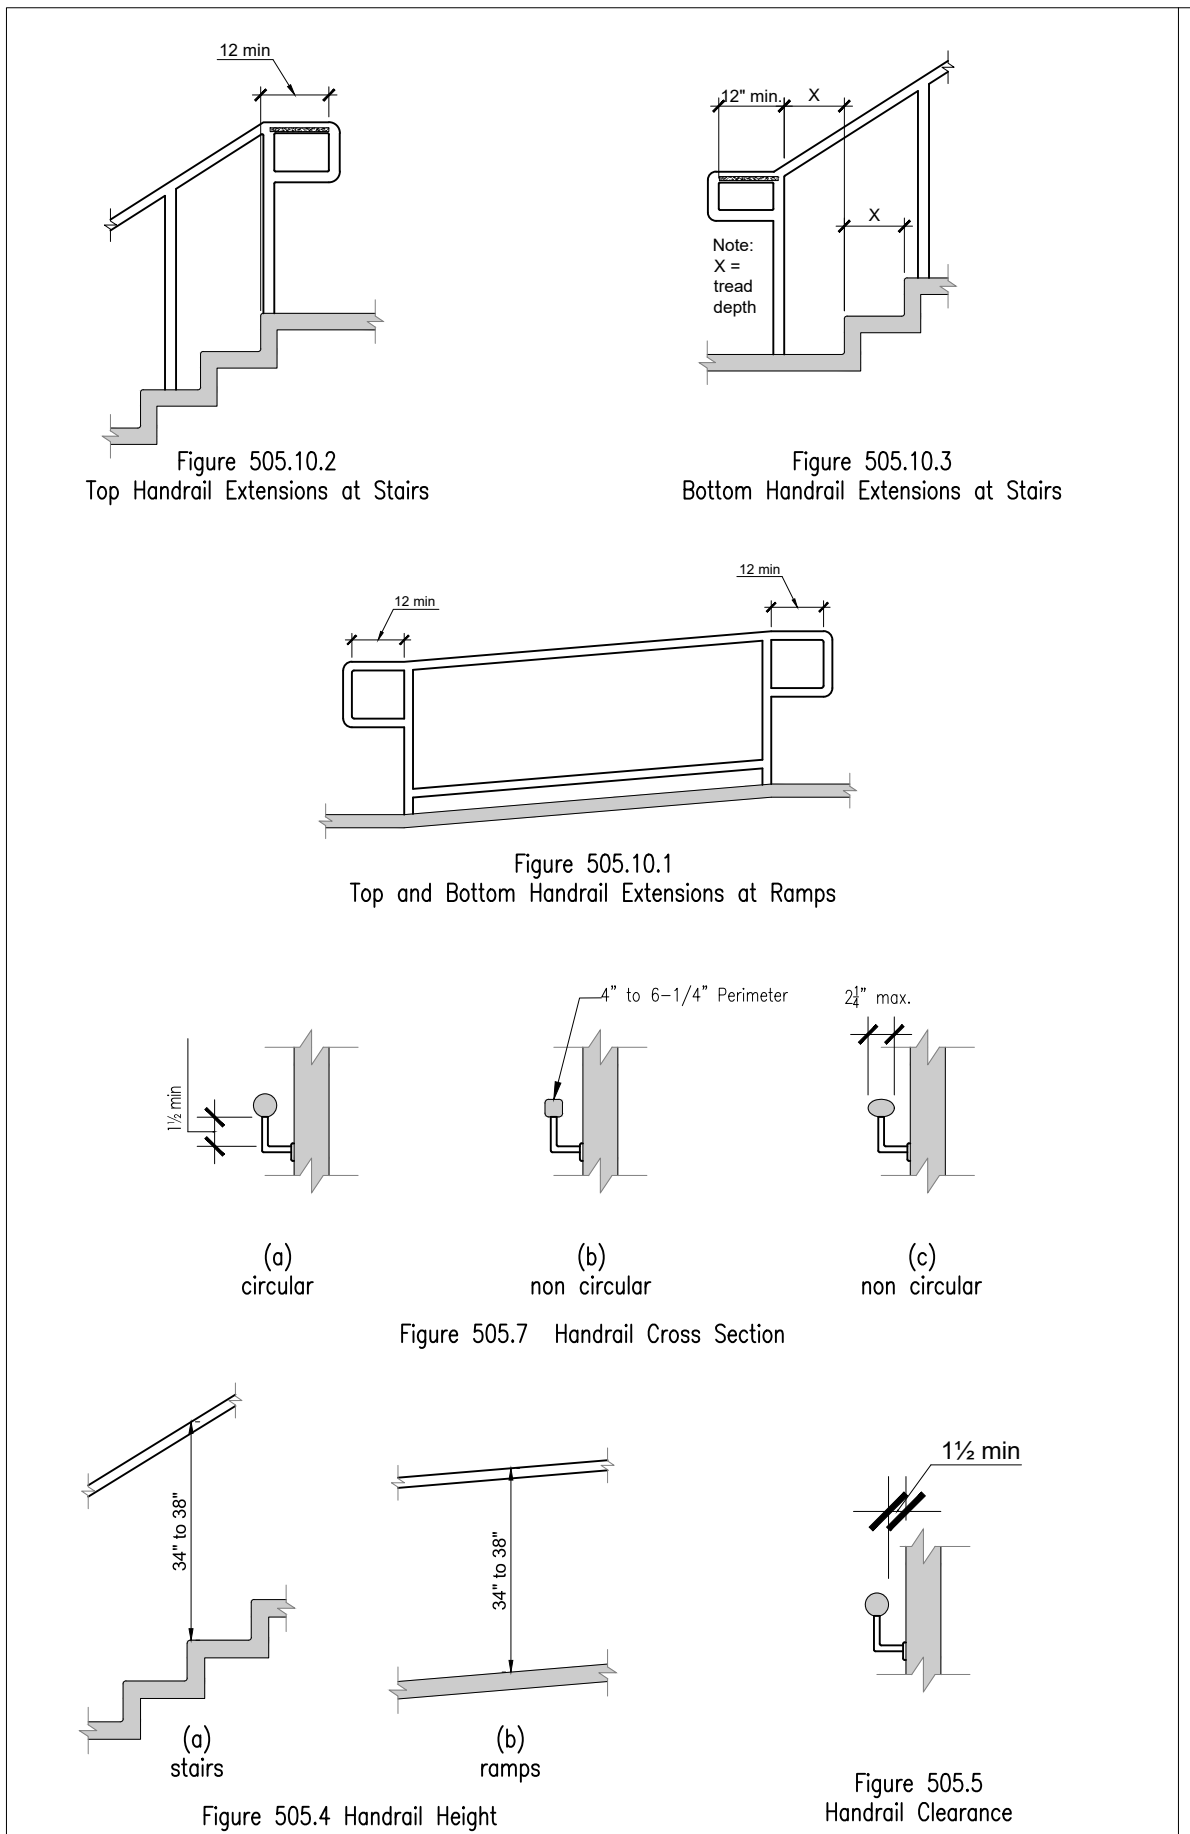
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 CODY, WYOMING 82414

SHEET TITLE
 GNRL - ACCESSIBILITY

SHEET NUMBER

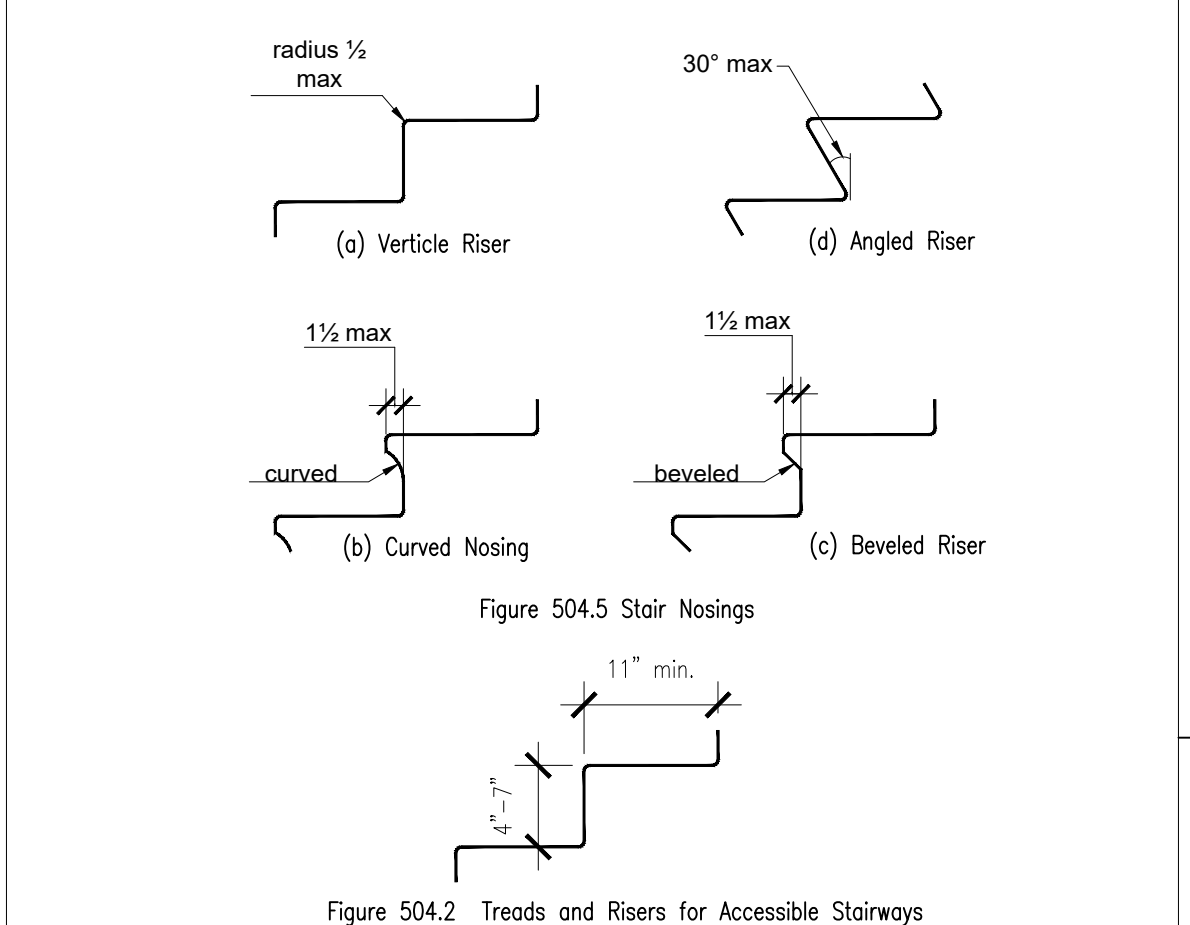
G121

SHEET: OF:



505.2 Location. Handrails shall be provided on both sides of stairs and ramps.
505.3 Continuity. Handrails shall be continuous within the full length of each stair flight or ramp run. Inside handrails on switchback or dogleg stairs or ramps shall be continuous between flights or runs. Other handrails shall comply with Sections 505.10 and 307.
505.4 Height. Top of gripping surfaces of handrails shall be 34" minimum and 38" maximum vertically above stair nosings and ramp surfaces. Handrails shall be at a consistent height above stair nosings and ramp surfaces.
505.5 Clearance. Clear space between handrail and wall shall be 1-1/2" minimum.
505.6 Gripping Surface. Gripping surfaces shall be continuous, without interruption by newel posts, or other construction elements or obstructions.
505.7 Cross Section. Handrails shall have a circular cross-section with an outside diameter of 1-3/4" minimum and 2" maximum, or shall provide equivalent graspability complying with section 505.7.1.
505.7.1 Non-Circular Cross Sections. Handrails with other shapes shall be permitted provided they have a perimeter dimension of 4" minimum and 6-3/4" maximum and their largest cross-section dimension is 2-3/4" maximum.
505.10.1 Top and Bottom Extension at Ramps. Ramp handrails shall extend horizontally 12" minimum beyond the top and bottom of ramp runs. Such extension shall return to a wall, guard, or the walking surface, or shall be continuous to the handrail of an adjacent ramp run.
505.10.2 Top Extensions at Stairs. At the top of a stair flight, handrails shall extend horizontally above the landing for 12" minimum, beginning directly above the first riser nosing. Such extension shall return to a wall, guard or the walking surface, or shall be continuous to the handrail of an adjacent stair flight.
505.10.3 Bottom Extension at Stairs. At the bottom of a stair flight, handrails shall extend at the slope of the stair flight for a distance equal to one tread depth beyond the last riser nosing. Such extension shall continue with a horizontal extension shall be continuous to the handrail of an adjacent stair flight, or shall return to a wall, guard or the walking surface. If provided at the bottom of a stair flight, a horizontal extension of a handrail shall be 12" long, minimum, and a height equal to that of the sloping portion of the handrail, as measured above the stair nosings. Such extension shall return to a wall, guard or the walking surface, or shall be continuous to the handrail of an adjacent stair flight.

505 Handrails J



504.2 Treads and Risers. All steps on a flight of stairs shall have uniform riser heights and uniform tread depth. Risers shall be 4" high minimum and 7" maximum. Treads shall be 11" deep minimum, measured from riser to riser. (Fig. 504.2)
504.3 Open Risers. Open risers shall not be permitted.
504.4 Tread Surface. Stair treads shall comply with Section 302.
504.5 Nosings. The radius of curvature of the leading edge of the tread shall be 3/4" maximum. Nosings that project beyond risers shall have the underside of the leading edge curved or beveled. Risers shall be permitted to slope under the tread at an angle of 30° maximum from vertical. The permitted projection of the nosing shall be 1-3/4" maximum beyond the tread level.
504.6 Handrails. Stairs shall have handrails complying with Section 505.

504 Stairways 6 H

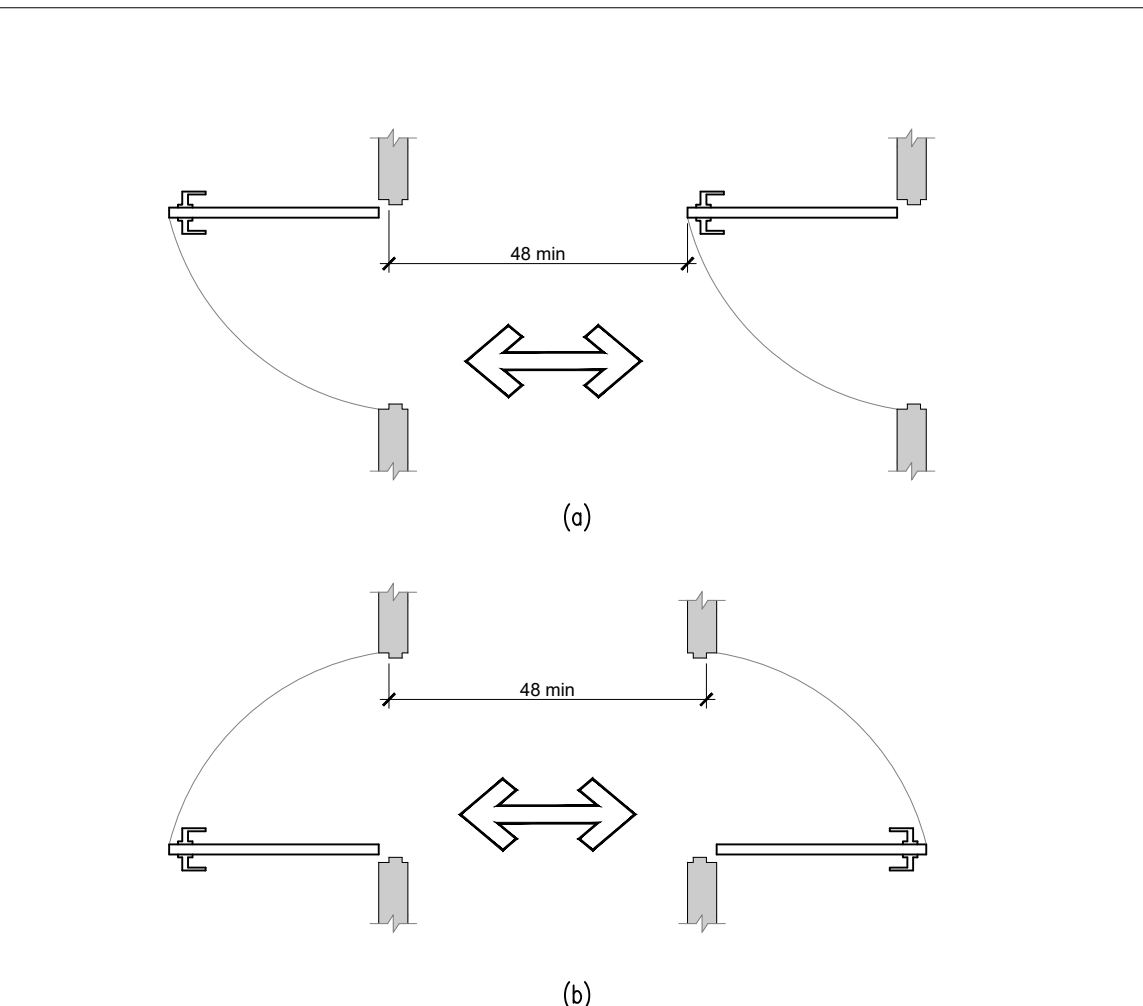


Figure 404.2.6 Two Doors in Series

APPROACH DIRECTION	MINIMUM CLEARANCES	
	Perpendicular to Doorway (1)	
From Front	48"	
From Side	42"	

NOTES:
 (1) Maneuvering space shall include full width of doorway.

Table 404.2.4.3 --- Maneuvering Clearances for Doorways without Doors

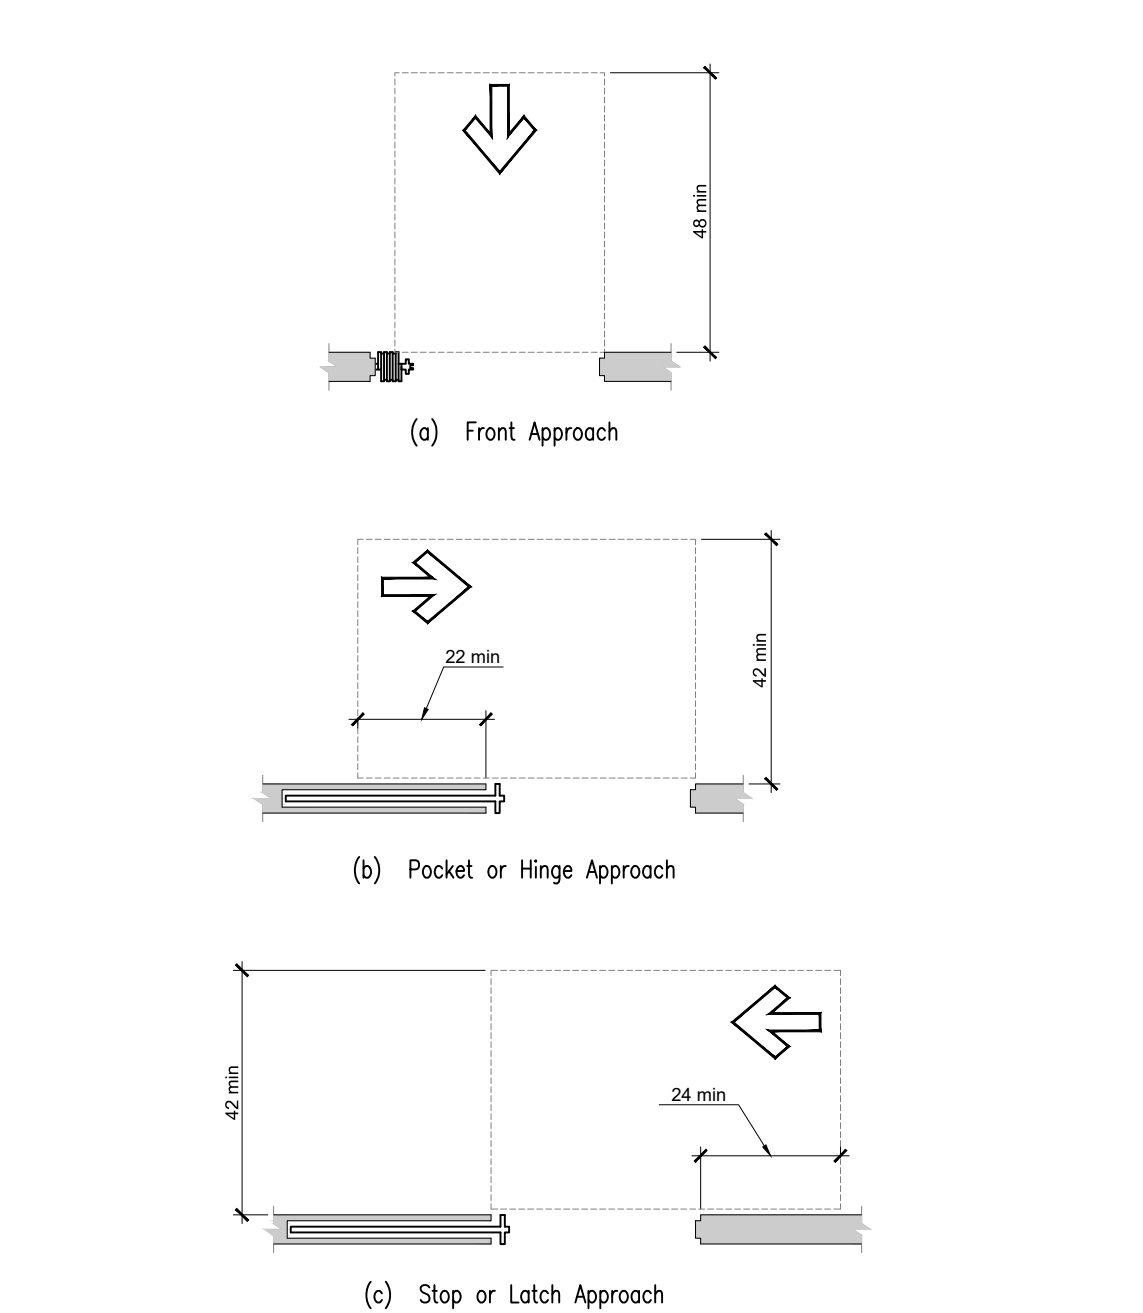


Figure 404.2.4.2 --- Maneuvering Clearances at Sliding and Folding Doors

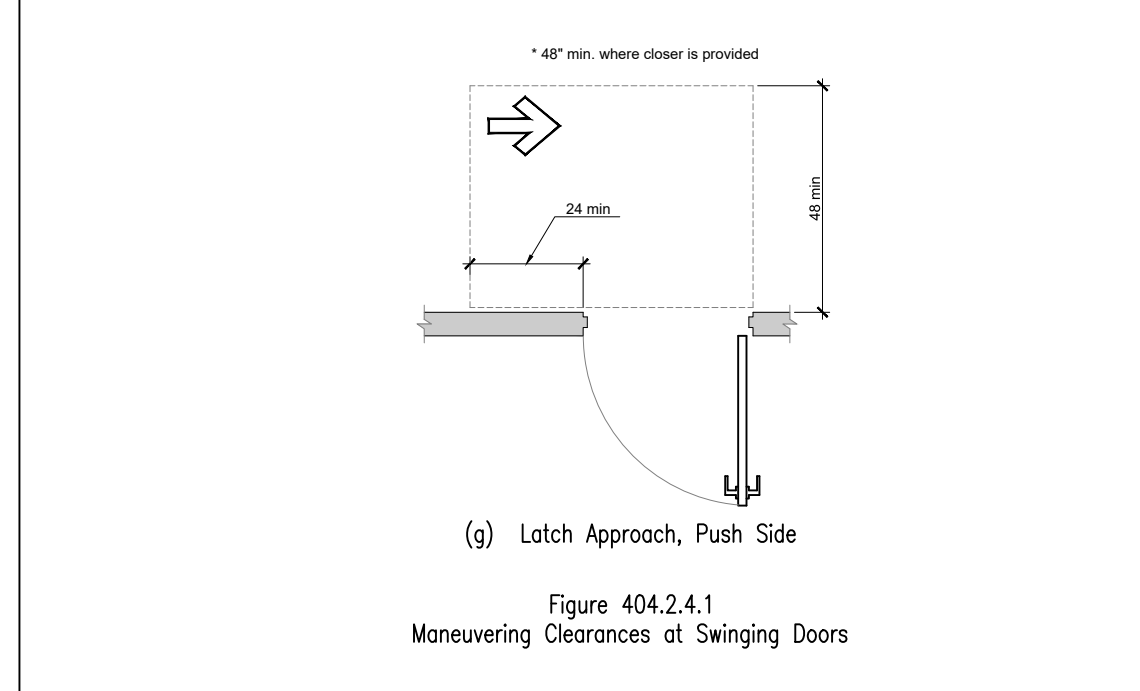
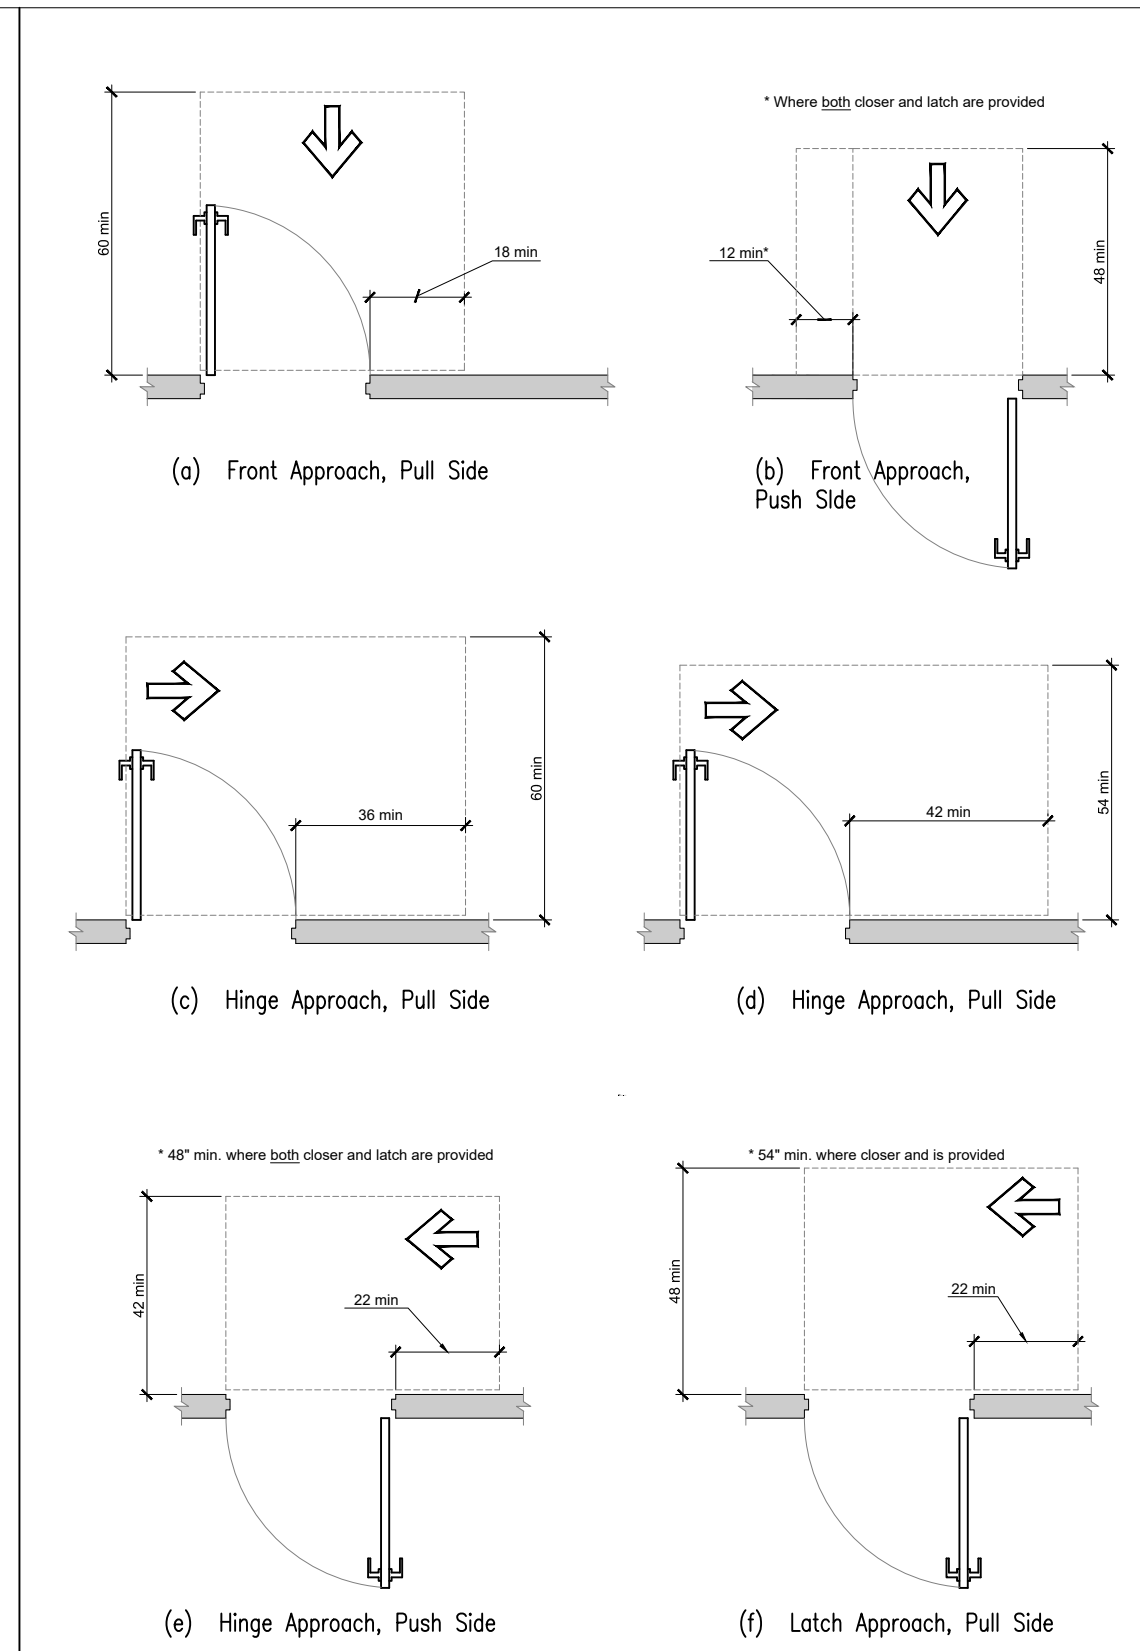
APPROACH DIRECTION	MINIMUM CLEARANCES	
	Perpendicular to Door (1)	Parallel to Door
From Front	48"	0"
From Hinge Side	42"	54" (2)
From Latch Side	42"	24" (2)

NOTES:
 (1) Maneuvering space shall include full width of doorway.
 (2) From latch side towards the doorway.

Table 404.2.4.2 --- Maneuvering Clearances for Sliding and Folding Doors

404.2.1 Revolving Doors and Turnstiles. Revolving doors or turnstiles shall not be part of an accessible route.
404.2.2 Double-Leaf Doorways. At least one of the active leaves of doorways with two independently operated leaves shall comply with ICC/ANSI A117.1-1998 Sections 404.2.3 and 404.2.4.
404.2.3 Clear Width. Doorways shall have a clear opening of 32" minimum. Clear opening of doorways with swinging doors shall be measured between the face of door and stop, with the door open 90°. Openings more than 24" deep shall provide a clear opening of 36" minimum. There shall be no projections into the clear opening within lower than 34" above the floor and ground. Projections into the minimum clear opening width more than 34" and up to 80" above the floor or ground are permitted but shall not exceed 4". (Fig. 404.2.3)
404.2.4 Maneuvering Clearances at Doors. (See Tables 404.2.4.1, 404.2.4.2 and 404.2.4.3; and see Figs. 404.2.4.1, 404.2.4.2 and 404.2.6)
404.2.4.1 Swinging Doors. Swinging doors shall have maneuvering clearances complying with Table 404.2.4.1.
404.2.4.2 Sliding and Folding Doors. Sliding doors and folding doors shall have maneuvering clearances complying with Table 404.2.4.2.
404.2.4.3 Doorways without Doors. Doorways without doors that are less than 36" wide shall have maneuvering clearances complying with Table 404.2.4.3.
404.2.4.4 Recessed Doors. Where the plane of the doorway is recessed clearances for front approach shall be provided.
404.2.4.5 Floor or Ground Surfaces. Floor or ground surfaces within the maneuvering clearances shall have a slope not steeper than 1:48 and shall comply with section 302.
404.2.5 Thresholds at Doorways. Thresholds, if provided, at doorways shall be 3/4" high maximum. Raised thresholds and changes in level at doorways must comply with sections 302 and 303.
404.2.6 Two Doors in Series. Distance between two hinged or pivoted doors in series shall be 48" minimum plus the width of any door swinging into the space.
404.2.7 Door Hardware. Handles, pulls, latches, locks and other operable parts on accessible doors shall have a shape that is easy to grasp with one hand and does not require tight grasping, pinching or twisting of the wrist to operate. Such hardware shall be 34" minimum and 48" maximum above the floor or ground. Where sliding doors are in the fully open position, operating hardware shall be exposed and usable from both sides.
 Exception: Locks used only for security purposes and not used for normal operation are permitted in any location.

404 Doors and Doorways 5



TYPE OF USE	Door Side	MINIMUM CLEARANCES	
		Perpendicular to Door (1)	Beyond Latch Parallel to Door
From Front	Pull	60"	18"
From Front	Push	48"	0" (2)
From Hinge	Pull	60"	36"
From Hinge	Push	54"	42"
From Latch	Pull	42" (3)	54"
From Latch	Push	48" (4)	24"
From Latch	Push	42" (4)	24"

NOTES:
 (1) Maneuvering space shall include full width of doorway.
 (2) Add 12" if closer and latch provided.
 (3) Add 6" if closer and latch provided.
 (4) Add 6" if closer provided.

Table 404.2.4.1 --- Maneuvering Clearances of Manual Swinging Doors

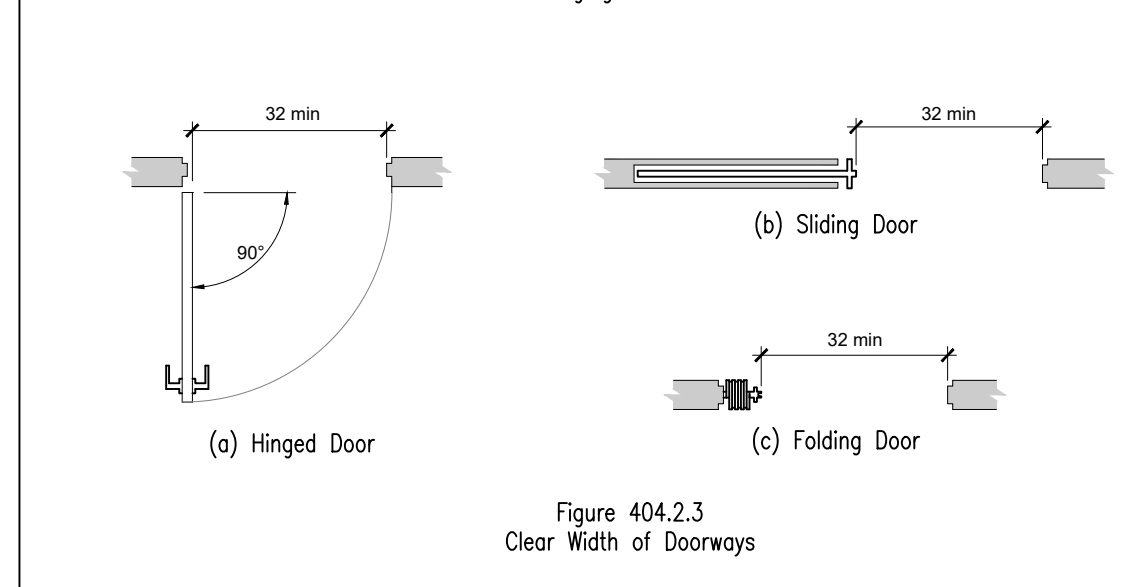
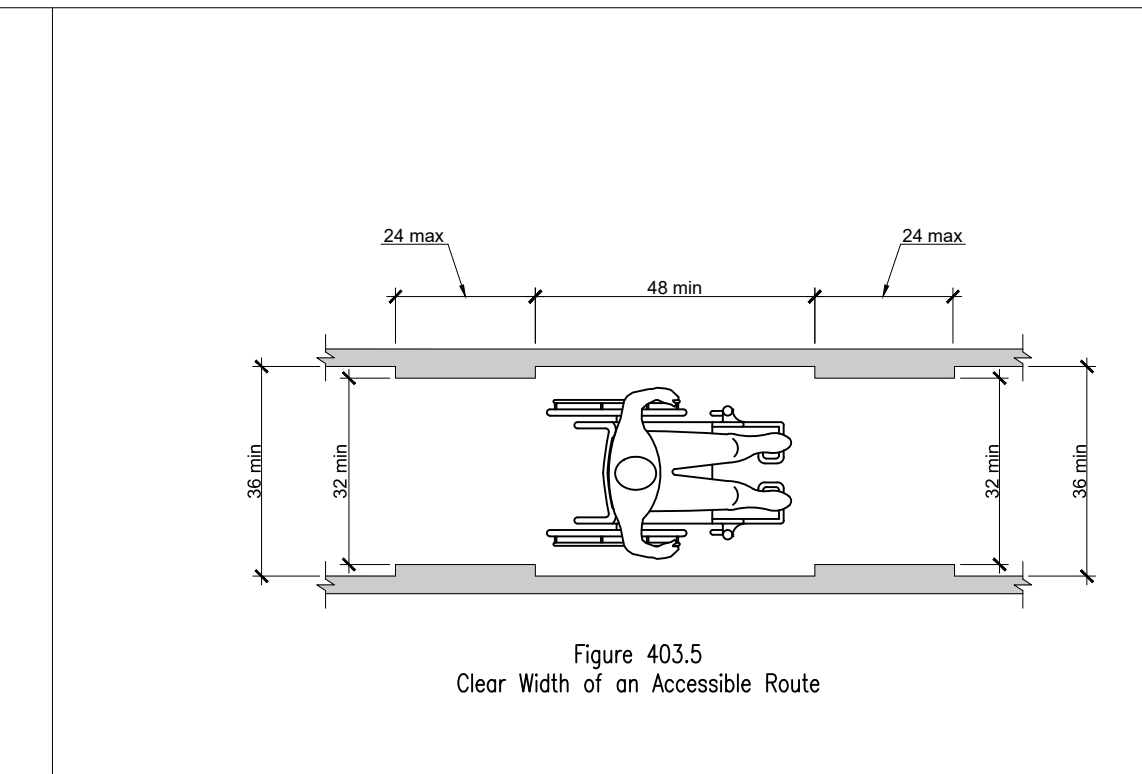


Figure 404.2.3 Clear Width of Doorways

404.2.1 Revolving Doors and Turnstiles. Revolving doors or turnstiles shall not be part of an accessible route.
404.2.2 Double-Leaf Doorways. At least one of the active leaves of doorways with two independently operated leaves shall comply with ICC/ANSI A117.1-1998 Sections 404.2.3 and 404.2.4.
404.2.3 Clear Width. Doorways shall have a clear opening of 32" minimum. Clear opening of doorways with swinging doors shall be measured between the face of door and stop, with the door open 90°. Openings more than 24" deep shall provide a clear opening of 36" minimum. There shall be no projections into the clear opening within lower than 34" above the floor and ground. Projections into the minimum clear opening width more than 34" and up to 80" above the floor or ground are permitted but shall not exceed 4". (Fig. 404.2.3)
404.2.4 Maneuvering Clearances at Doors. (See Tables 404.2.4.1, 404.2.4.2 and 404.2.4.3; and see Figs. 404.2.4.1, 404.2.4.2 and 404.2.6)
404.2.4.1 Swinging Doors. Swinging doors shall have maneuvering clearances complying with Table 404.2.4.1.
404.2.4.2 Sliding and Folding Doors. Sliding doors and folding doors shall have maneuvering clearances complying with Table 404.2.4.2.
404.2.4.3 Doorways without Doors. Doorways without doors that are less than 36" wide shall have maneuvering clearances complying with Table 404.2.4.3.
404.2.4.4 Recessed Doors. Where the plane of the doorway is recessed clearances for front approach shall be provided.
404.2.4.5 Floor or Ground Surfaces. Floor or ground surfaces within the maneuvering clearances shall have a slope not steeper than 1:48 and shall comply with section 302.
404.2.5 Thresholds at Doorways. Thresholds, if provided, at doorways shall be 3/4" high maximum. Raised thresholds and changes in level at doorways must comply with sections 302 and 303.
404.2.6 Two Doors in Series. Distance between two hinged or pivoted doors in series shall be 48" minimum plus the width of any door swinging into the space.
404.2.7 Door Hardware. Handles, pulls, latches, locks and other operable parts on accessible doors shall have a shape that is easy to grasp with one hand and does not require tight grasping, pinching or twisting of the wrist to operate. Such hardware shall be 34" minimum and 48" maximum above the floor or ground. Where sliding doors are in the fully open position, operating hardware shall be exposed and usable from both sides.
 Exception: Locks used only for security purposes and not used for normal operation are permitted in any location.

404 Doors and Doorways 5

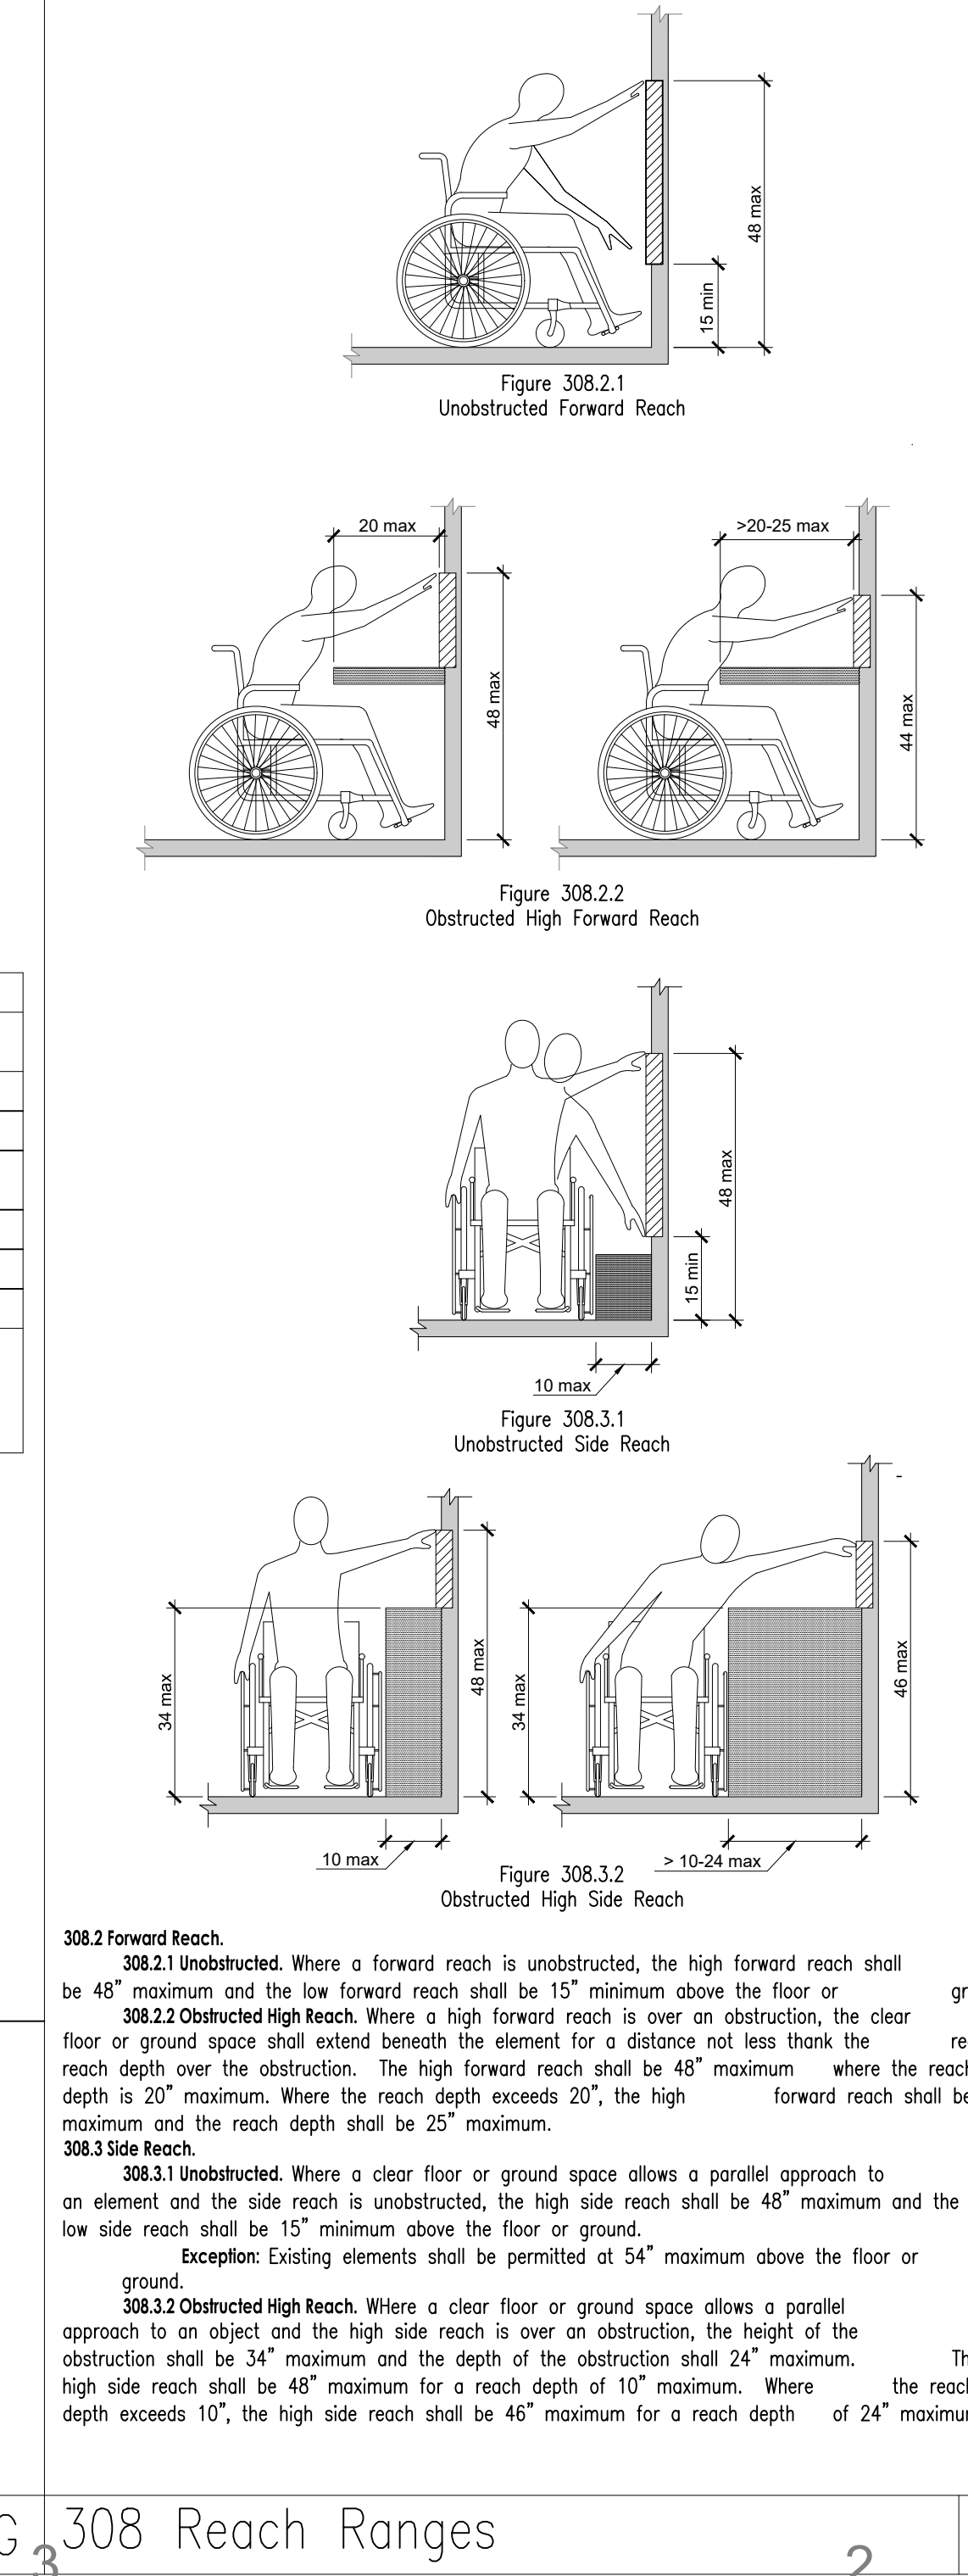


Segment Length	Minimum Segment Width
Less Than or Equal to 24"	32" (See Note)
Greater Than 24"	36"

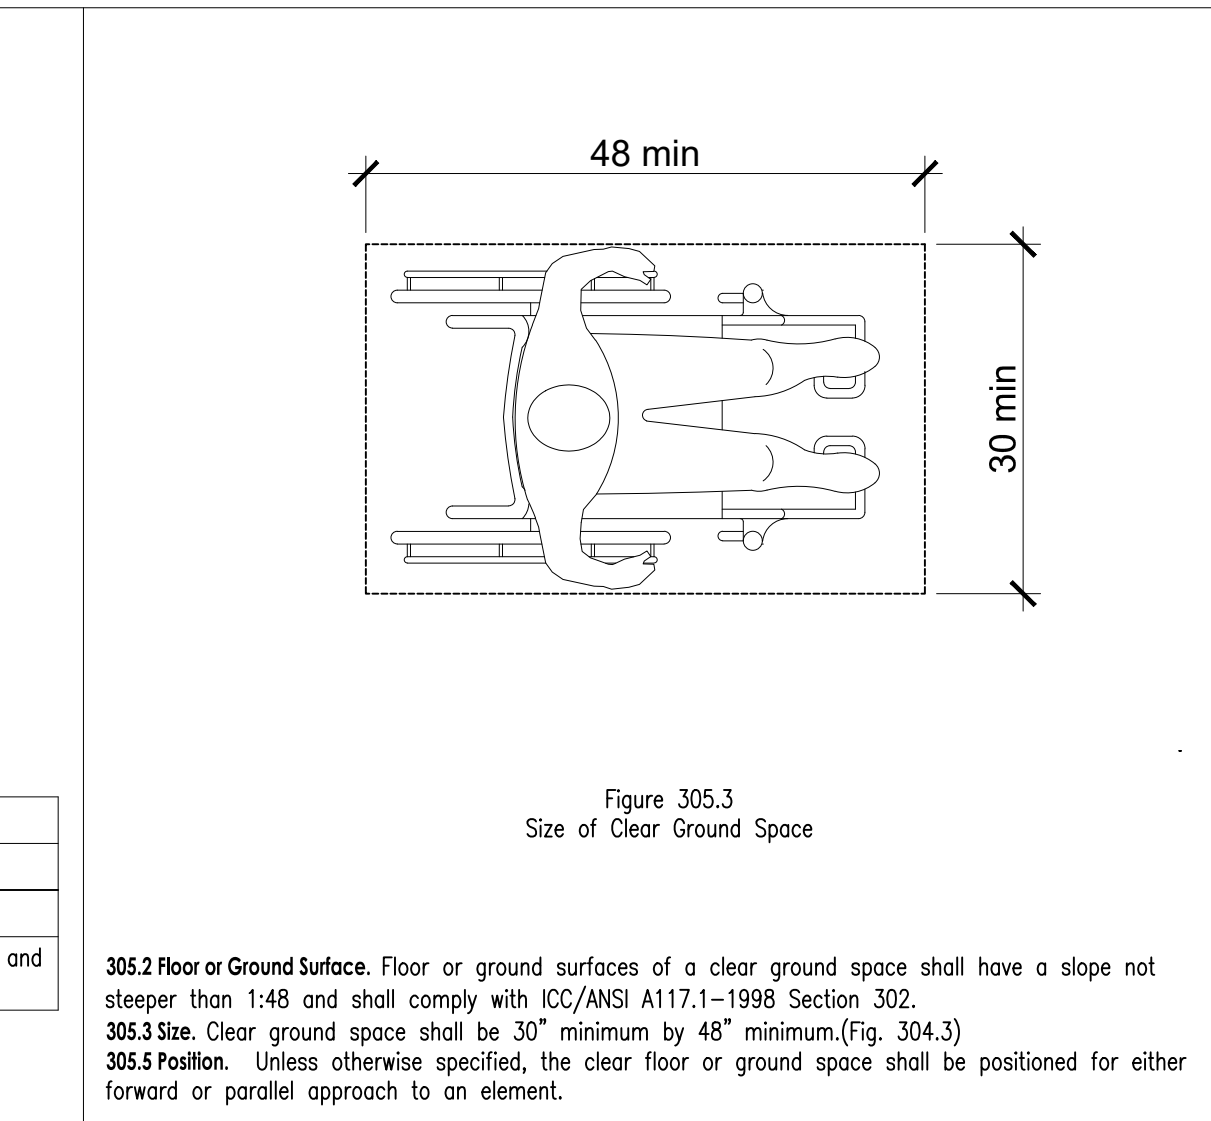
Note: Consecutive segments of 32" wide must be separated by a route segment 48" long minimum and 36" wide minimum.

Table 403.5 Clear Width of an Accessible Route

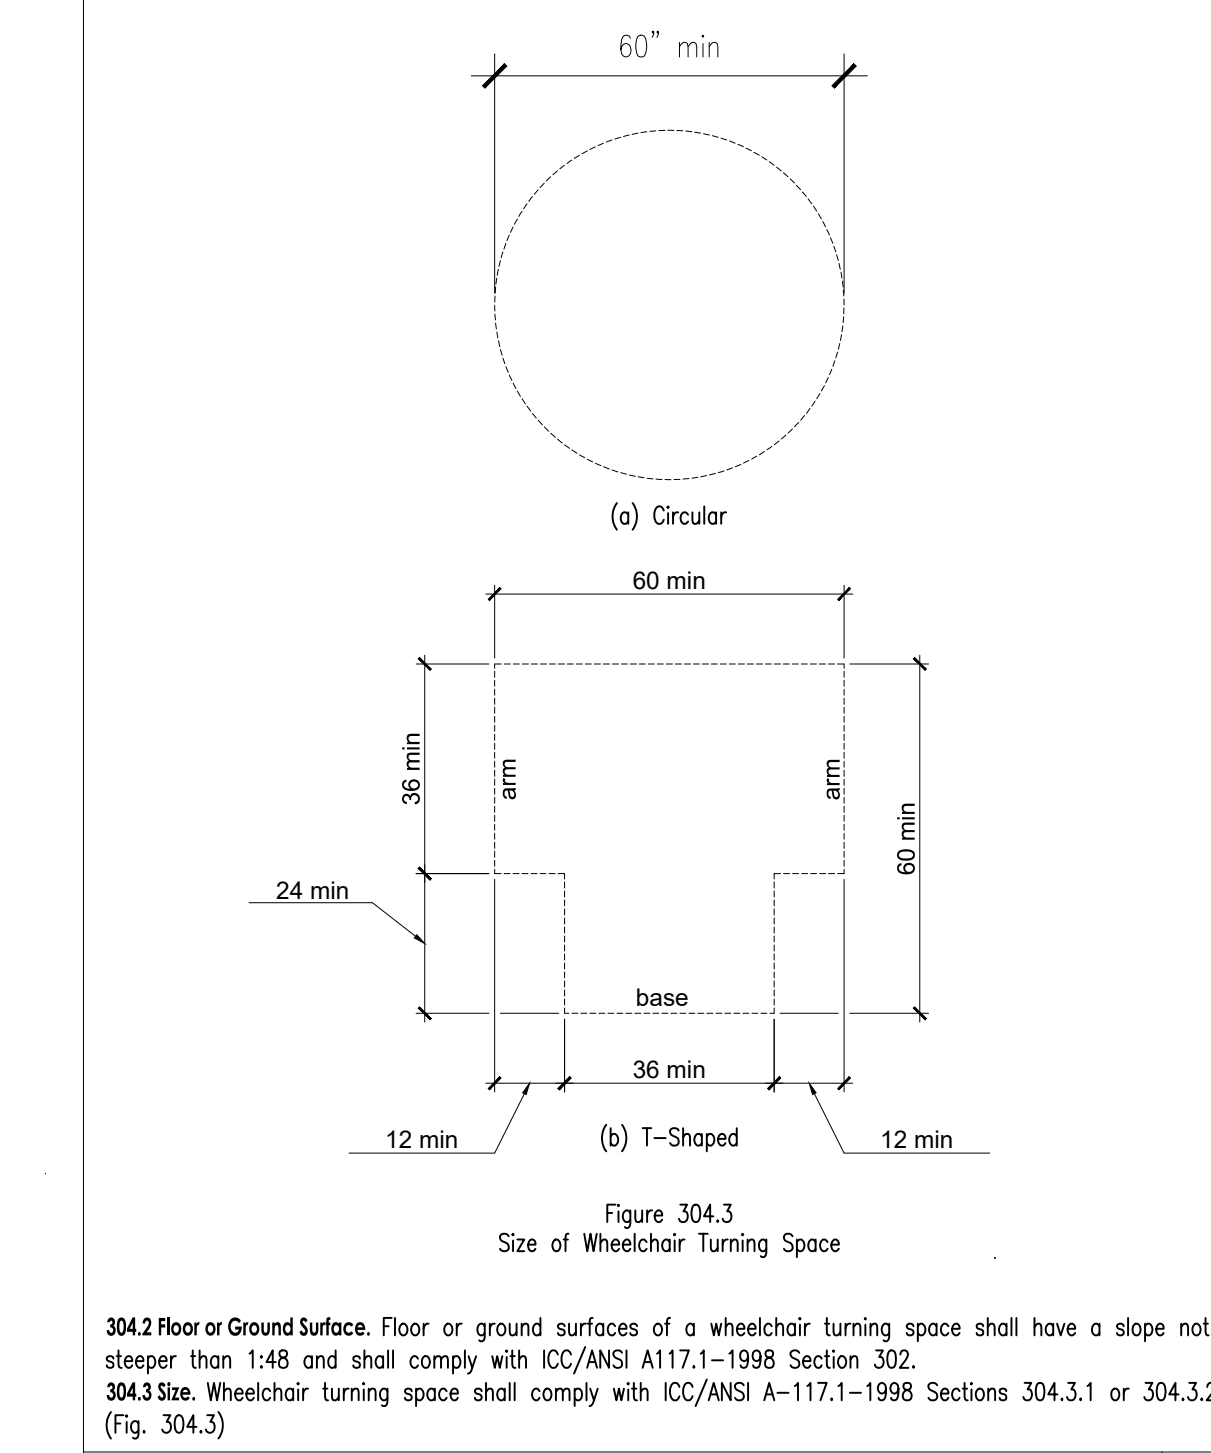
403.5 Clear Width of an Accessible Route F



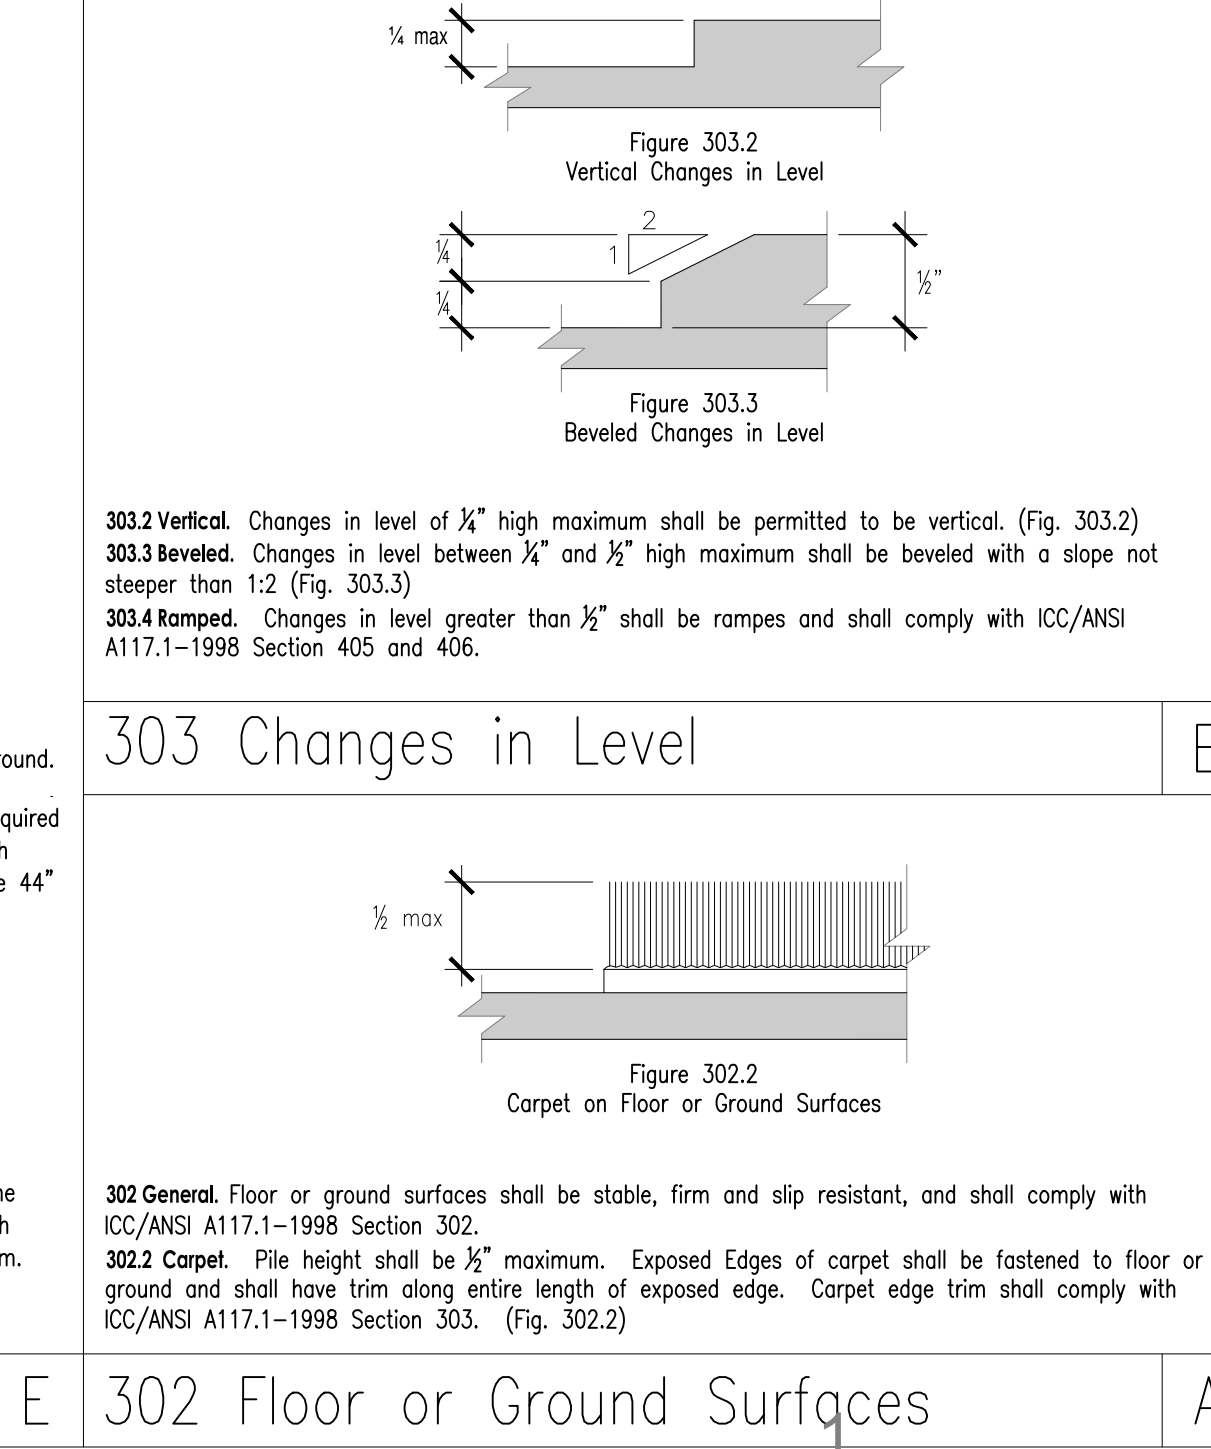
308 Reach Ranges 2 E



305 Clear Ground Space D



304 Wheelchair Turning Space C



302 Floor or Ground Surfaces A

APPLICABLE CODES:

ALL WORK MUST COMPLY WITH THE FOLLOWING, APPLICABLE CODES:

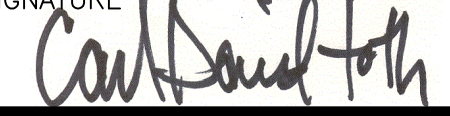
- 2018 INTERNATIONAL BUILDING CODE (IBC)
- 2018 INTERNATIONAL MECHANICAL CODE (IMC)
- 2018 INTERNATIONAL PLUMBING CODE (IPC)
- 2018 INTERNATIONAL FUEL GAS CODE (IFGC)
- 2020 NATIONAL ELECTRICAL CODE (NEC)
- 2018 INTERNATIONAL FIRE CODES

CODE ANALYSIS:

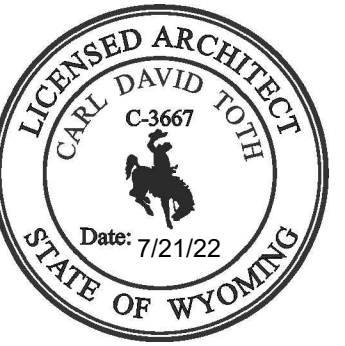
CONSTRUCTION TYPE: VB
 OCCUPANCY CLASSIFICATION: A-3, ASSEMBLY
 OCCUPANCY LOAD: 293 OCCUPANTS
 BUILDING HEIGHT: 17' TO RIDGE
 GROSS FLOOR AREA: 2,896 G.S.F.

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REVISIONS

MARK	DATE	INIT.	DESCRIPTION

PROJECT TITLE

CIAD - WYOMING
 5 NEX PERCE DRIVE
 CODY, WYOMING 82414

SHEET TITLE
 GNRL - CODE
 ANALYSIS

SHEET NUMBER

G131

SHEET: OF:

GENERAL NOTES:

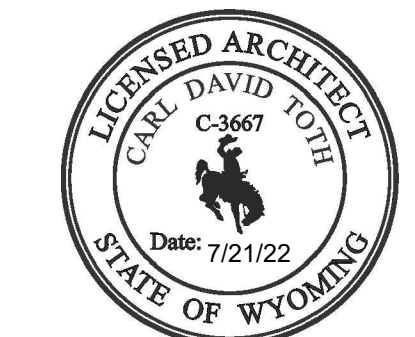
- AG01: COMPLY WITH INTERNATIONAL BUILDING CODE (I.B.C.) AND ALL APPLICABLE FEDERAL, STATE, MUNICIPAL AND LOCAL CODES, ORDINANCES, STANDARDS, AND REGULATIONS.
- AG02: FACILITY CONSTRUCTION TYPE: V-B (COMBUSTIBLE, NON RATED).
- AG03: AREA: 2,896 GSF
- AG04: OCCUPANCY: FACILITY IS A-3 OCCUPANCY (CHURCH)
OCCUPANCY LOAD:
SEE LIFE SAFETY SHEET (G141) FOR OCCUPANCY CALCULATIONS
TOTAL = 293 OCCUPANTS
- AG05: EXITS REQUIRED: 2
BUILDINGS WITH UP TO 500 OCCUPANTS MUST HAVE TWO EXITS IN ACCORDANCE WITH IBC SECTION 1006.3 AND TABLE 1006.3.1. ALL EXIT DOORS MUST SWING IN THE DIRECTION OF EGRESS TRAVEL IN ACCORDANCE WITH IBC SECTION 1010.1.2.1 OCCUPANT LOAD AND TRAVEL DISTANCE BOTH EXCEED REQUIREMENTS FOR 1 1 ALLOWING 1 EXIT.
- AG06: AUTOMATIC SPRINKLER SYSTEM: BUILDING IS NOT REQUIRED TO HAVE AN AUTOMATIC SPRINKLER SYSTEM BASED ON THE FIRE AREA AND OCCUPANT LOAD SPECIFIED IN 903.2.1.3

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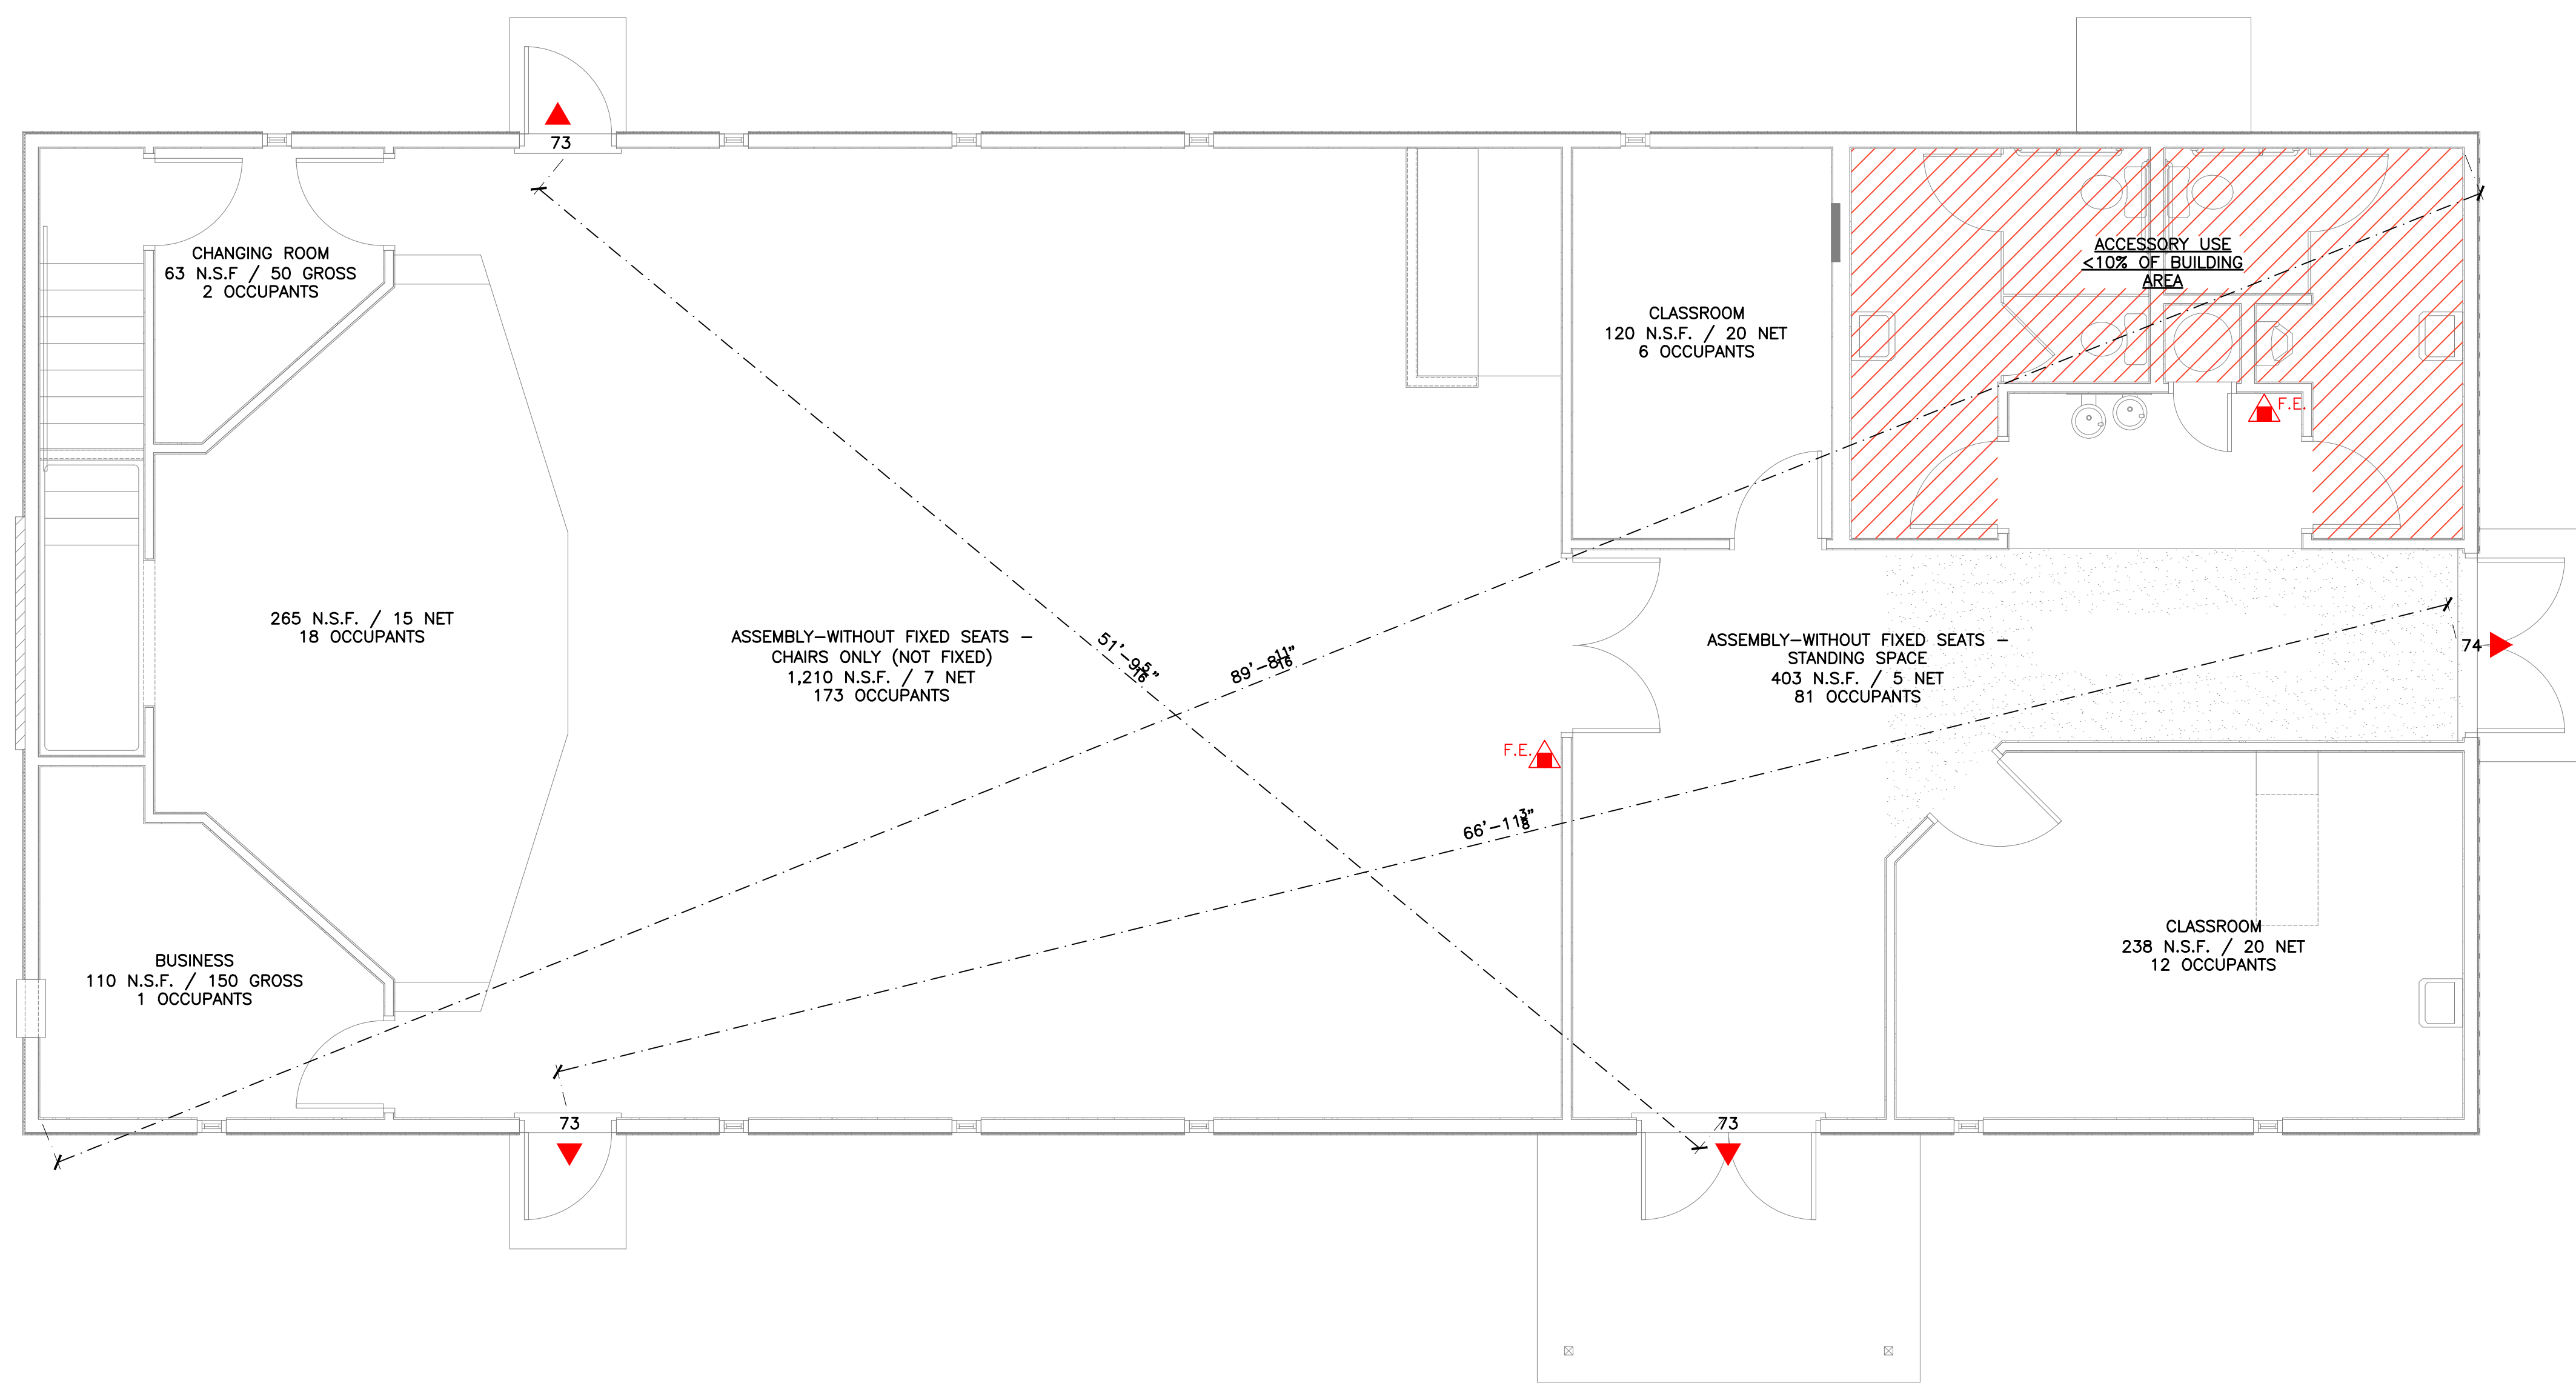


LEGEND:

- 2-HOUR RATED WALL, (NOT USED)
- 1-HOUR RATED WALL, (NOT USED)

10% ACCESSORY USE

- EXIT DISCHARGE DOOR (TO PUBLIC WAY):
NOTE: ALL DOORS MUST SWING IN DIRECTION OF EGRESS TRAVEL WHERE SERVING AN OCCUPANT LOAD OF 50 OR MORE.
- FIRE EXTINGUISHER: 2A:10B:C PER NFPA 10 AND INDIANAPOLIS LOCAL ORDINANCE AND AS INDICATED



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PROJECT TITLE

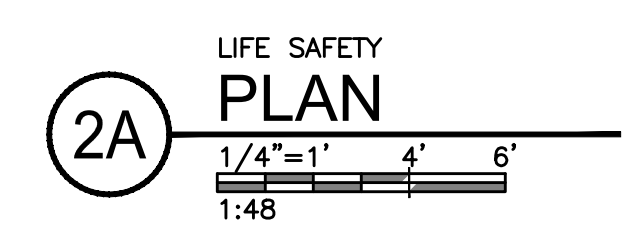
CIAD - WYOMING
5 NEX PERCE DRIVE
CODY, WYOMING 82414

SHEET TITLE
GNRL - LIFE SAFETY

SHEET NUMBER

G141

SHEET: OF:



FOUNDATION NOTES:

1. THIS FOUNDATION PLAN IS PROVIDED FOR LAYOUTS AND BIDDING PURPOSES AND IS TO SERVE AS A GENERAL GUIDE FOR MINIMUM REQUIREMENTS. NO WARRANTY IS EXPRESSED OR IMPLIED AS TO THE PERFORMANCE OF THIS FOUNDATION UNDER ALL SITE CONDITIONS OR FOR ANY SPECIFIC LOCATION. IT IS THE CONTRACTOR'S RESPONSIBILITY TO VERIFY JOBSITE CONDITIONS FOR THE APPLICABILITY OF THIS FOUNDATION DESIGN. OBTAIN SOILS TESTING AND/OR ENGINEERING SERVICES AS MAY BE REQUIRED AND/OR EMPLOY MATERIALS AND PROCEDURES WHICH HAVE PROVEN TO BE SATISFACTORY UNDER SIMILAR CONDITIONS.
2. PRIOR TO FOUNDATION WORK, STRIP TOPSOIL A MINIMUM OF 4" AND REMOVE ALL FOREIGN MATERIAL WITHIN THE FOUNDATION AREA, I.E. TREES, ROOTS, TRUMPS, GRASSES, HUMAS AND OTHER DELETERIOUS MATERIALS AS REQUIRED.
3. CONSTRUCT BUILDING PAD OF SELECT GRANULAR FILL/BINDER AS REQUIRED FOR ELEVATION OF TOP OF SLAB AND TO PROVIDE POSITIVE DRAINAGE AWAY FROM THE FOUNDATION IN ALL DIRECTIONS. FILL MATERIAL SHALL BE A MINIMUM OF 6" THICK AND SHALL BE COMPACTED IN LIFTS NOT TO EXCEED 6" TO A MINIMUM OF 80% DRY DENSITY (STANDARD BY PROCTOR DENSITY).
4. BOTTOMS OF FOOTING TRENCHES SHALL BE SMOOTH AND EXTEND INTO UNDISTURBED SOIL A MINIMUM OF 6" WITH 12" PENETRATION PREFERRED. TRENCH EDGES SHALL BE NEAT AND SQUARE. REFILLING OVER-EXCAVATED SECTIONS AND/OR SPOTS IS UNACCEPTABLE.
5. FORMWORK SHALL BE CLEAN AND FREE OF SURFACE IMPERFECTIONS WHICH WOULD MARR THE FINISHED APPEARANCE OF THE CONCRETE. FORMS SHALL BE LEVEL, TRUE, SQUARE AND BRACED ADEQUATELY TO MAINTAIN POSITION DURING CONCRETE PLACEMENT. CONCRETE SHALL BE AGITATED SUFFICIENTLY TO ELIMINATE HONEYCOMBS.
6. CONCRETE SHALL BE A MINIMUM OF 5-SACK MIX ATTAINING 3,000 PSI IN 28 DAYS. PORTLAND CEMENT IN THE CONCRETE MIX SHALL BE STANDARD BRAND, AMERICAN MANUFACTURED TO MEET ASTM SPECIFICATION C-150 TYPE 1. AGGREGATE IS TO BE FREE OF DIRT AND DEBRIS WITH A MAXIMUM DIAMETER OF 1-1/2". THE WATER IS TO BE CLEAN, ACID FREE AND SHALL NOT CONTAIN ALKALINE OR ORGANIC MATERIAL.
7. VAPOR BARRIER SHALL BE 6 MIL BLACK POLY. LAP ALL JOINTS 6" MIN. AND SEAL WITH TAPE. PATCH ALL BREAKS OR TEARS AND SEAL AROUND ANY PIPES OR ANY OTHER ITEMS PENETRATING THE MEMBRANE AND/OR CONCRETE. A VAPOR BARRIER IS REQ'D UNDER GARAGES, CARPORTS, STORAGE AREAS AND COVERED PORCHES OR PATIOS. A VAPOR BARRIER IS NOT REQUIRED UNDER SIDEWALKS, UNCOVERED PATIOS AND DRIVEWAYS.
8. ALL EXTERIOR GRADE BEAMS SHALL BE A MINIMUM OF 24" DEEP FROM TOP OF THE SLAB BY 12" WIDE. INTERIOR GRADE BEAMS SHALL BE A MINIMUM OF 18" DEEP FROM TOP OF SLAB BY 12" WIDE. MINIMUM SLAB THICKNESS SHALL BE 4".
9. REINFORCING STEEL SHALL BE DEFORMED NEW BILLET STEEL BARS IN ACCORDANCE WITH ASTM SPECIFICATION A-615 GRADE 50. ALL STIRRUPS SHALL BE GRADE 40 WITH STANDARD 90 DEGREE HOOKS. DETAILING OF REINFORCING STEEL SHALL CONFORM TO THE AMERICAN CONCRETE INSTITUTE DETAILING MANUAL.
10. REINFORCING GRADE BEAMS WITH A MINIMUM FOUR (2 PAIR) #5 BARS, CONTINUOUS WITH #3 STIRRUPS @ 36" O.C. MAX. VERTICAL SPACING OF #5 REBAR IN GRADE BEAMS SHALL BE 16" O.C. PROVIDE TWO #5x8-0" (4'-0" EA. LEG) 90° CORNER BARS TOP AND BOTTOM AT ALL CORNERS AND 7" INTERSECTIONS OF GRADE BEAMS. LAP ALL CONT. REBAR SPLICES A MIN. OF 40 BAR DIAMETERS. INSTALL THREE #5x6-0" DIAGONAL BARS AT INSIDE CORNERS. TACK WELDING OF REINF. STEEL DR. FIELD TORCH BENDS ARE NOT PERMITTED. CONCRETE SHALL COVER THE REINFORCING STEEL AS FOLLOWS: GRADE BEAMS - 1-1/2", 3" BOTTOM, 2" @ FORMED SIDES AND 3" @ SIDES AGAINST EARTH. SQUARE, RECTANGULAR OR CIRCULAR FOOTINGS - 3" MINIMUM.
11. REINFORCING 4" SLAB WITH #3 BARS AT 16" O.C. EACH WAY. INSTALL PLASTIC SUPPORTS AS REQUIRED TO MAINTAIN # REBAR GRID IN THE CENTER OF THE SLAB OR 6x6 10/10 WWM.
12. AT FLOOR PLATES, PROVIDE MIN. 1/2"x8" ANCHOR BOLTS @ 48" O.C. (TYP.), 24" O.C. w/1 6'-0" OF EXT. CORNERS.
13. BLOCKOUT FOR DOORS SHOWN ON THE FLOOR PLAN.
14. AT STEEL COLUMNS, PROVIDE STEEL BASE PLATES WELDED TO THE COLUMN AND EXTENDING BEYOND THE COLUMN A MIN. OF 2" ON ALL SIDES. ANCHOR TO CONC. W/ (4) 1/2" ANCHOR BOLTS OR 1/2" EXP. BOLTS. RECESS THE PLATE A MINIMUM 1-1/2" BELOW THE FINISHED SLAB AND COVER WITH CONCRETE TO MATCH THE SURROUNDING CONCRETE.
15. SLOPE CONCRETE SURFACE TO THE FLOOR DRAINS AS REQUIRED.
16. DROP SLAB A MINIMUM OF 1-1/2" AT MASONRY LUGS AND DROP MASONRY LUGS APPROXIMATELY 8" ABOVE GRADE.
17. IF A BRICK LEDGE IS DESIRED, INCREASE SLAB DIMENSIONS 5-1/2" ON EACH WALL WHERE THE BRICK LEDGE IS LOCATED AND DROP THIS PORTION OF THE SLAB 1-1/2". PERIMETER GRADE BEAM WILL REMAIN THE SAME WIDTH AND DEPTH AS PROVIDED HEREIN.
18. MACHINE TROWEL ENTIRE SLAB UNLESS OTHERWISE NOTED.
19. SLAB SURFACES SHALL NOT VARY MORE THAN 1/8" UNDER A 10'-0" LONG STRAIGHTEDGE.

LI

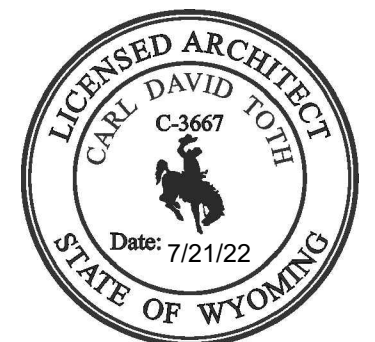
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REVISIONS

MARK	DATE	INIT.	DESCRIPTION

C

PROJECT TITLE

CIAD - WYOMING
 5 NEX PERCE DRIVE
 CODY, WYOMING 82414

B

SHEET TITLE
 STR - NOTES

A

SHEET NUMBER

S101

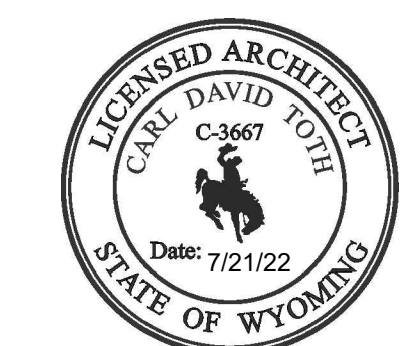
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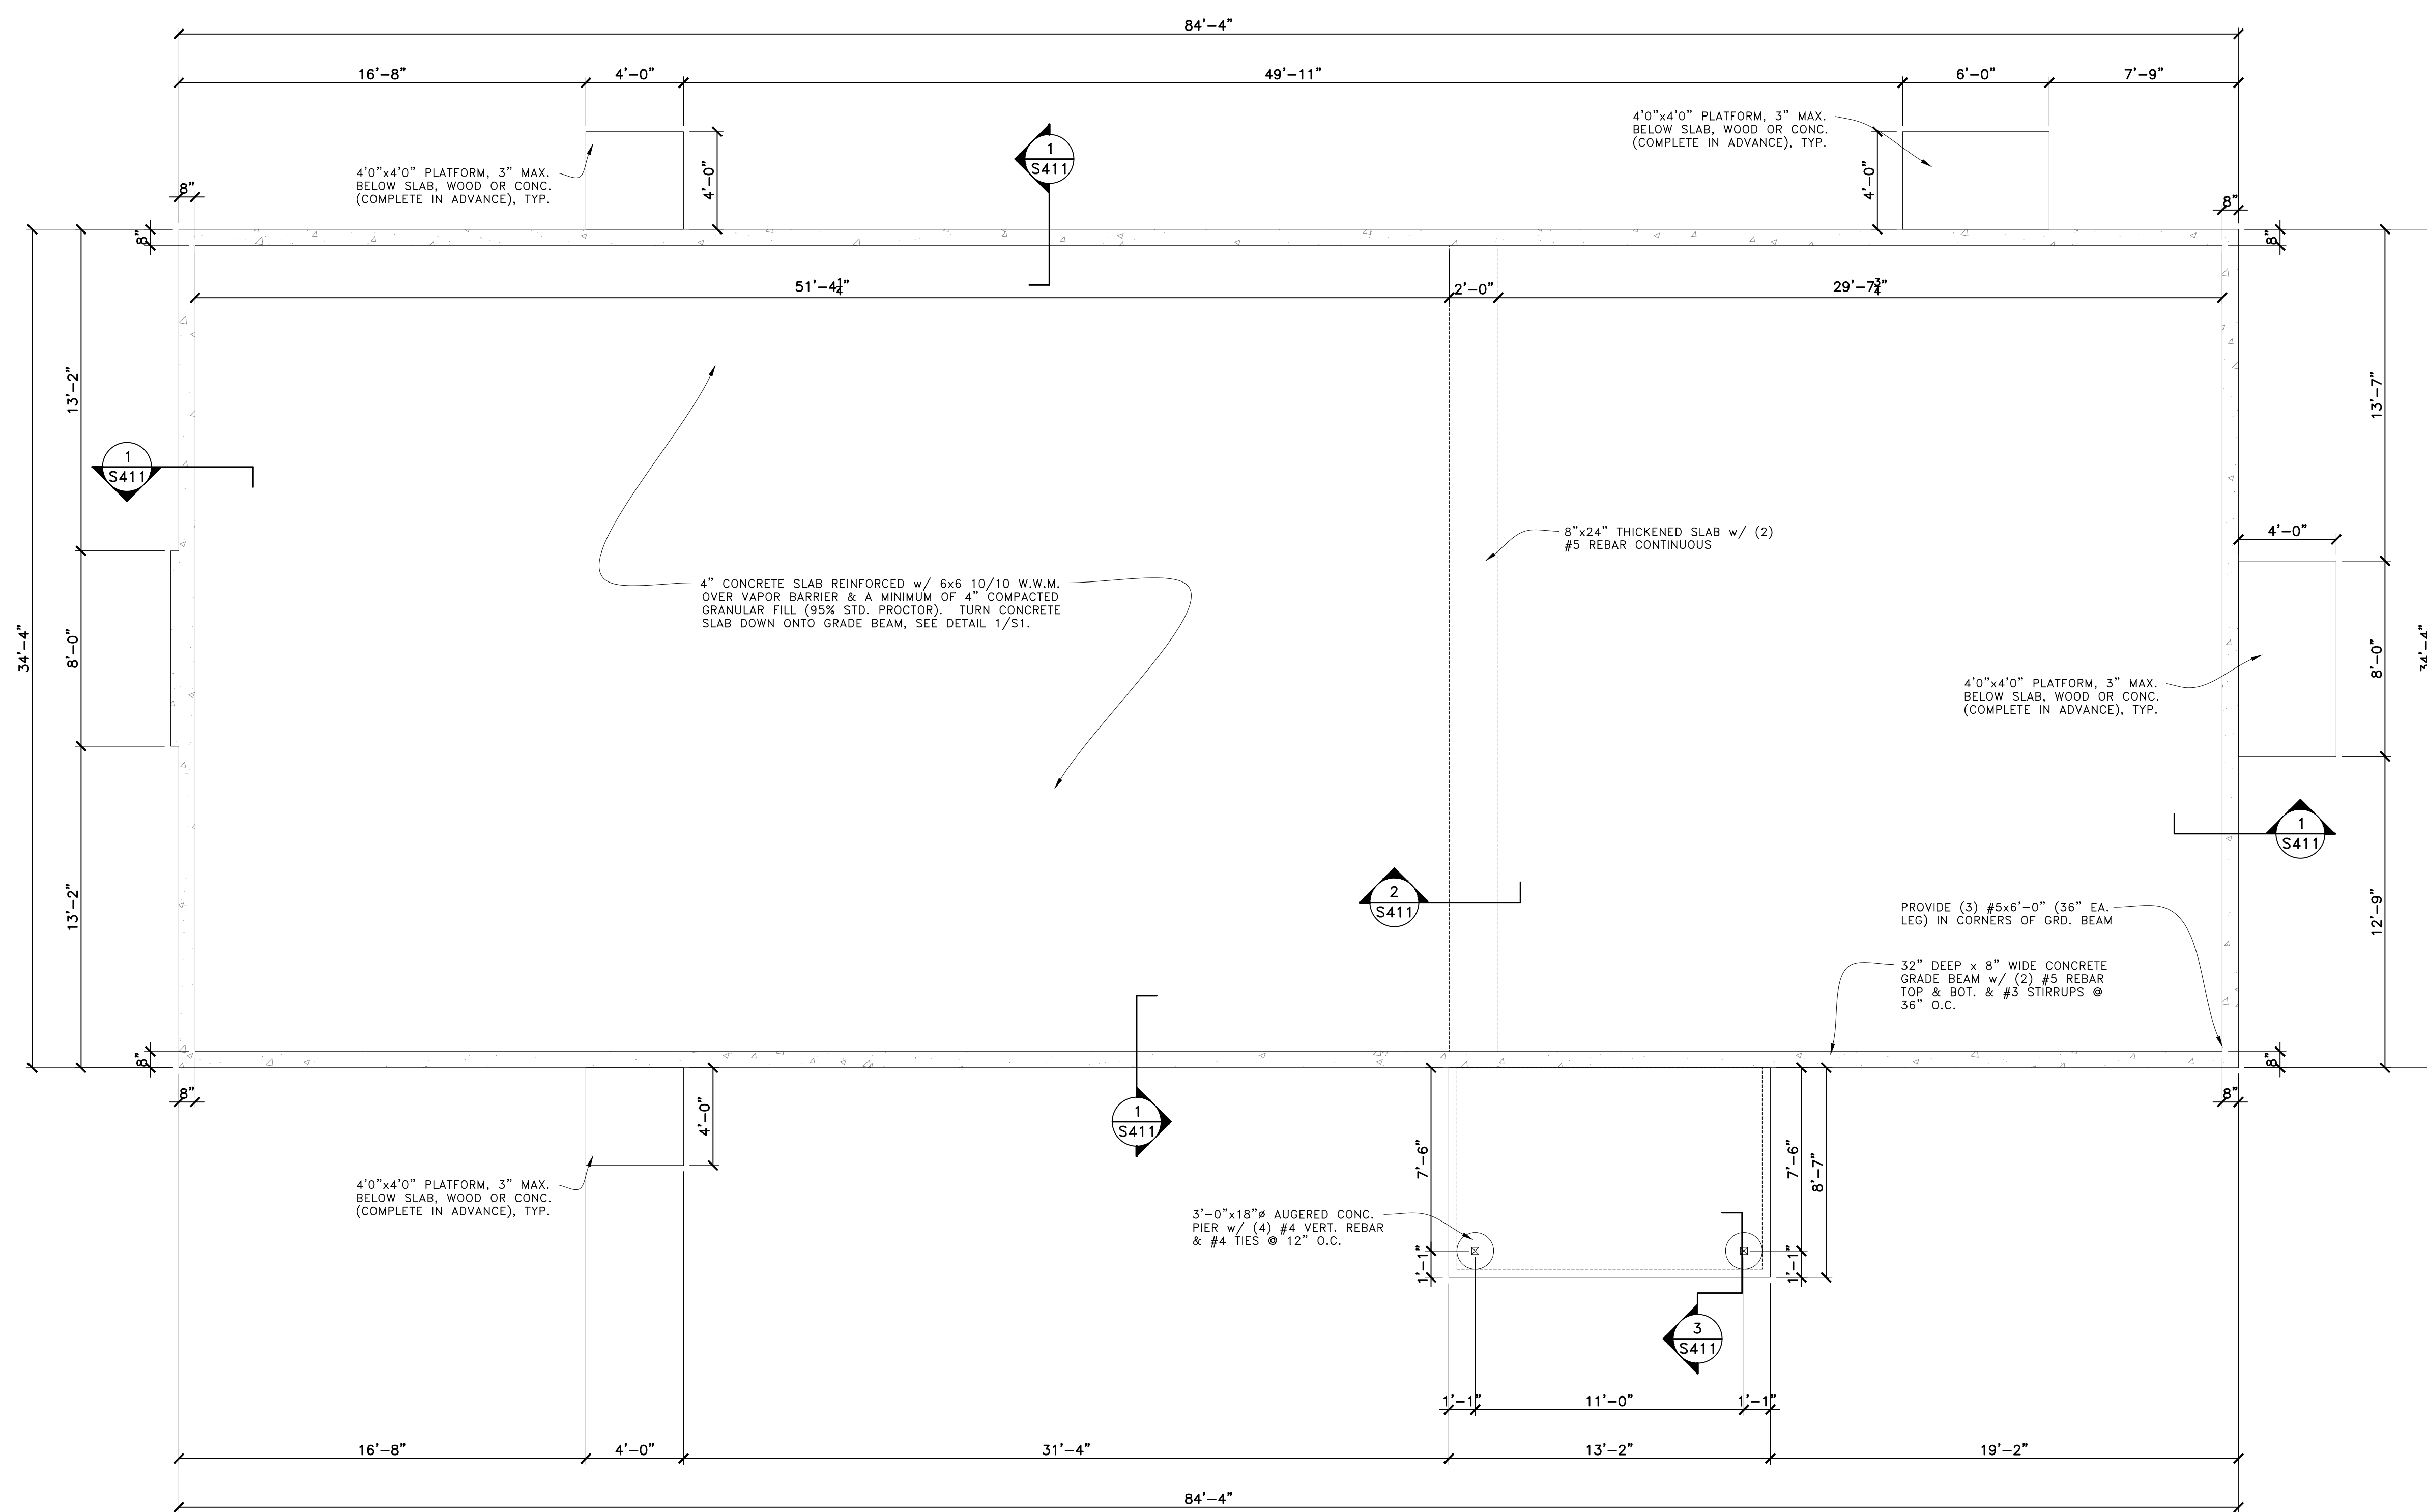
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PROJECT TITLE

CIAD - WYOMING
 5 NEX PERCE DRIVE
 CODY, WYOMING 82414

SHEET TITLE
 STR - FND - PLAN

SHEET NUMBER
S111
 SHEET: OF:



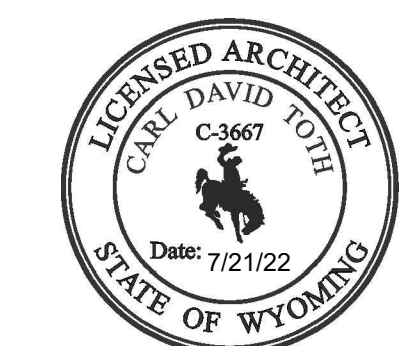
FOUNDATION PLAN
 PLAN
 1/4" = 1' 4" 6"
 1:48

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PROJECT TITLE

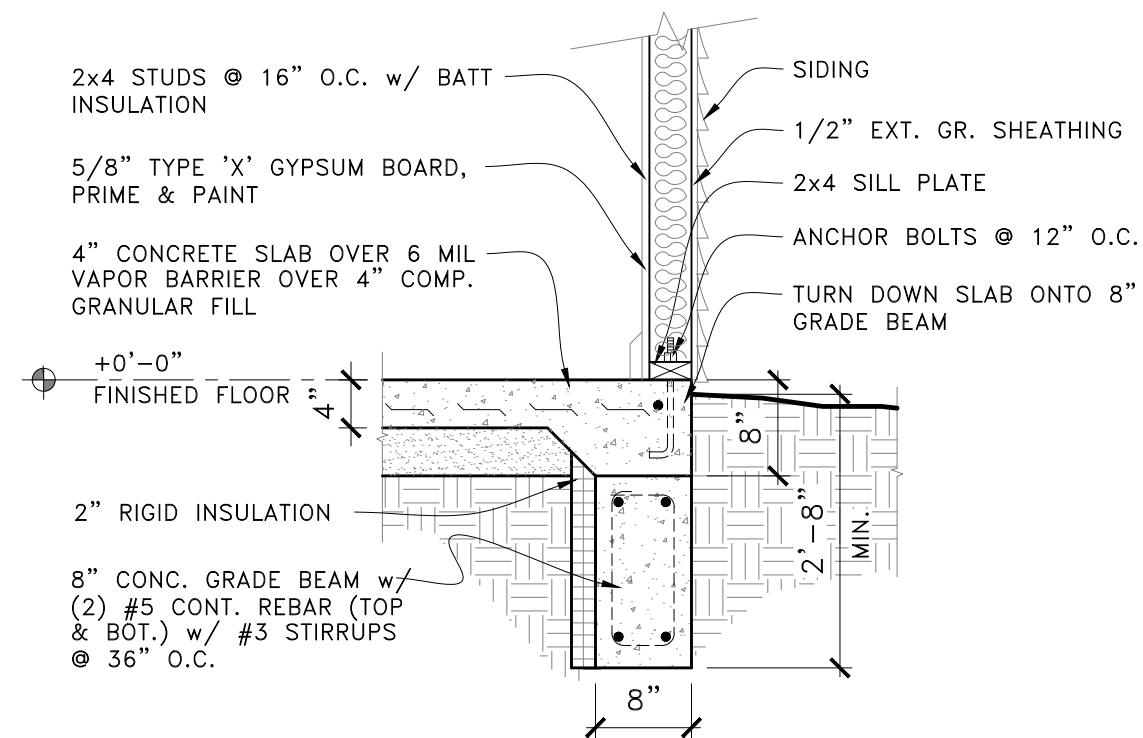
CIAD - WYOMING
 5 NEX PERCE DRIVE
 CODY, WYOMING 82414

SHEET TITLE
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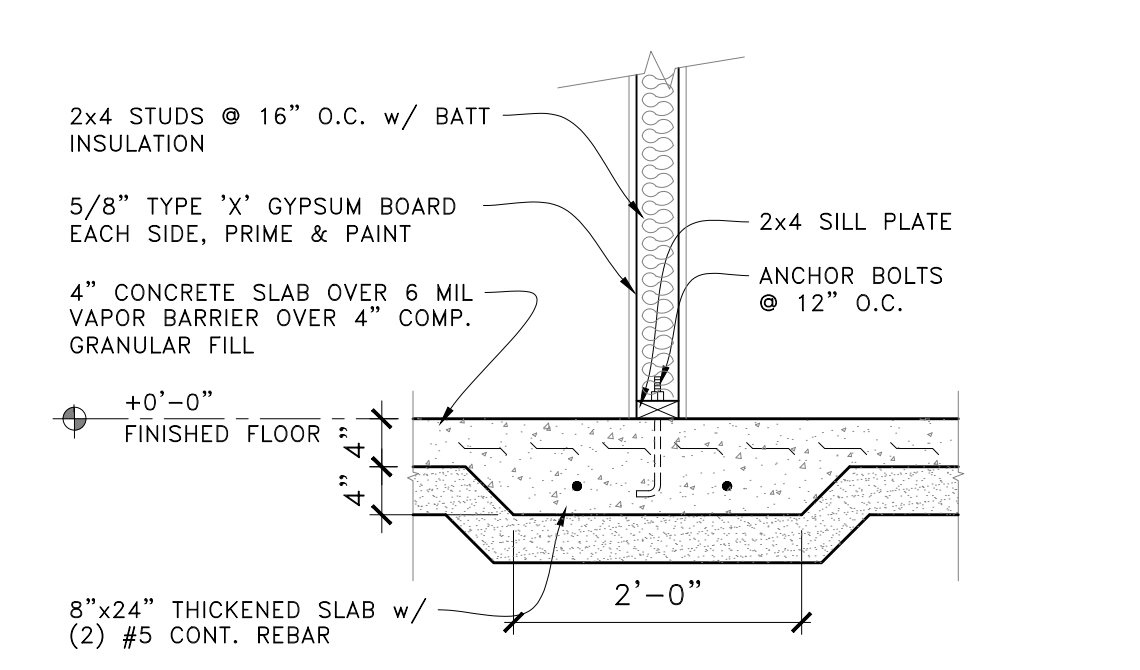
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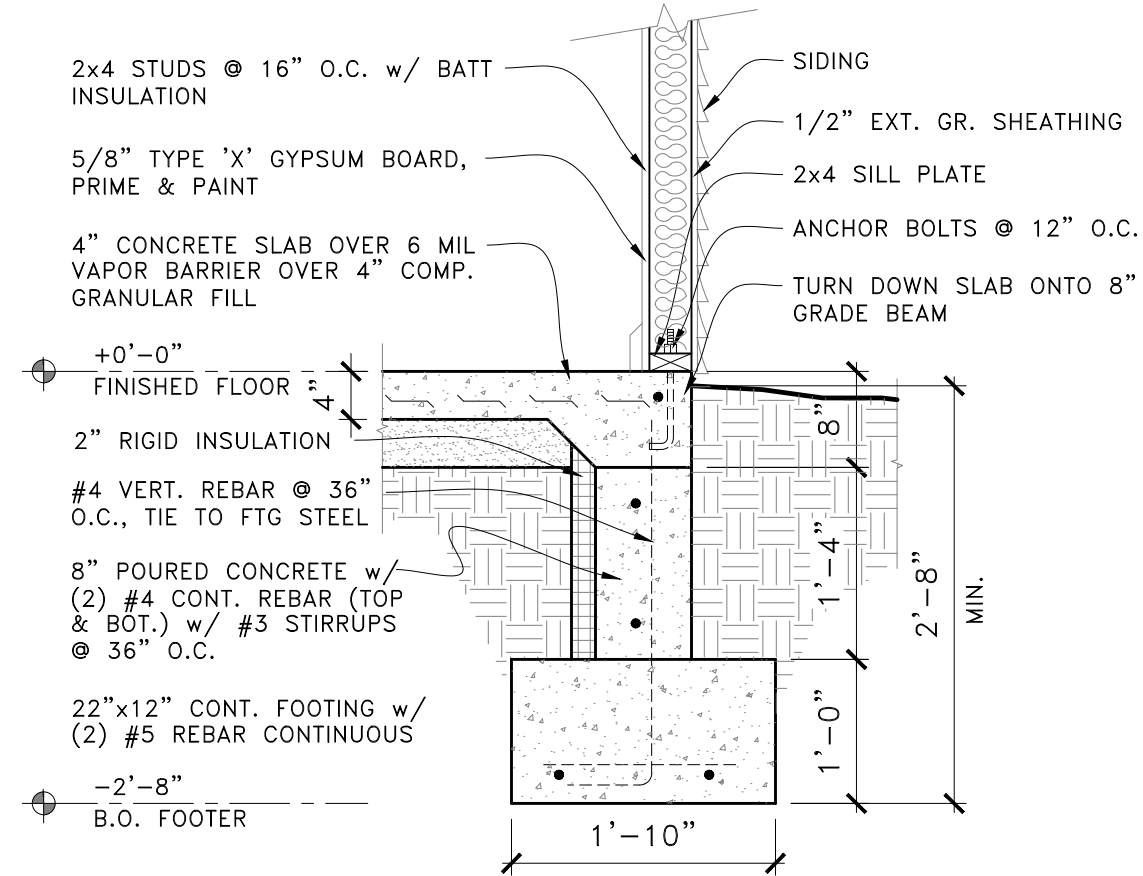
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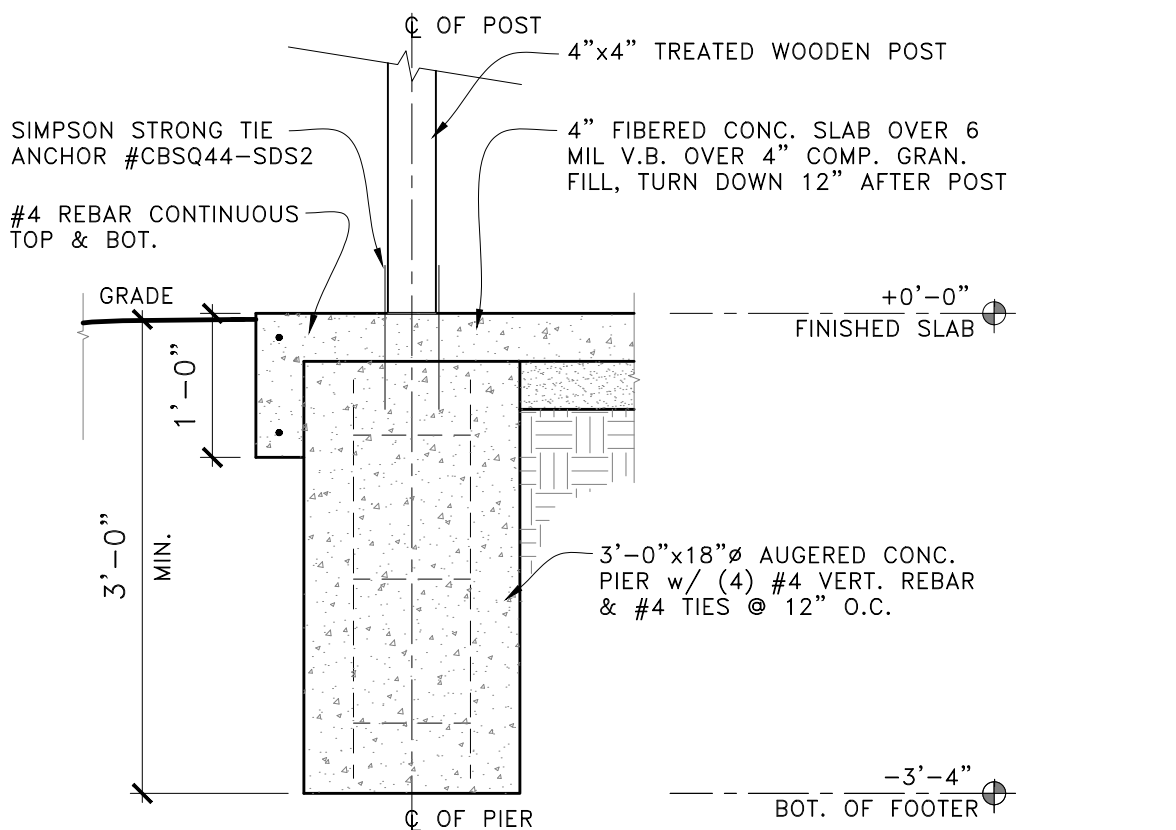
1 8" GRADE BEAM DETAIL
 S1 SCALE: 3/4" = 1'-0" 01



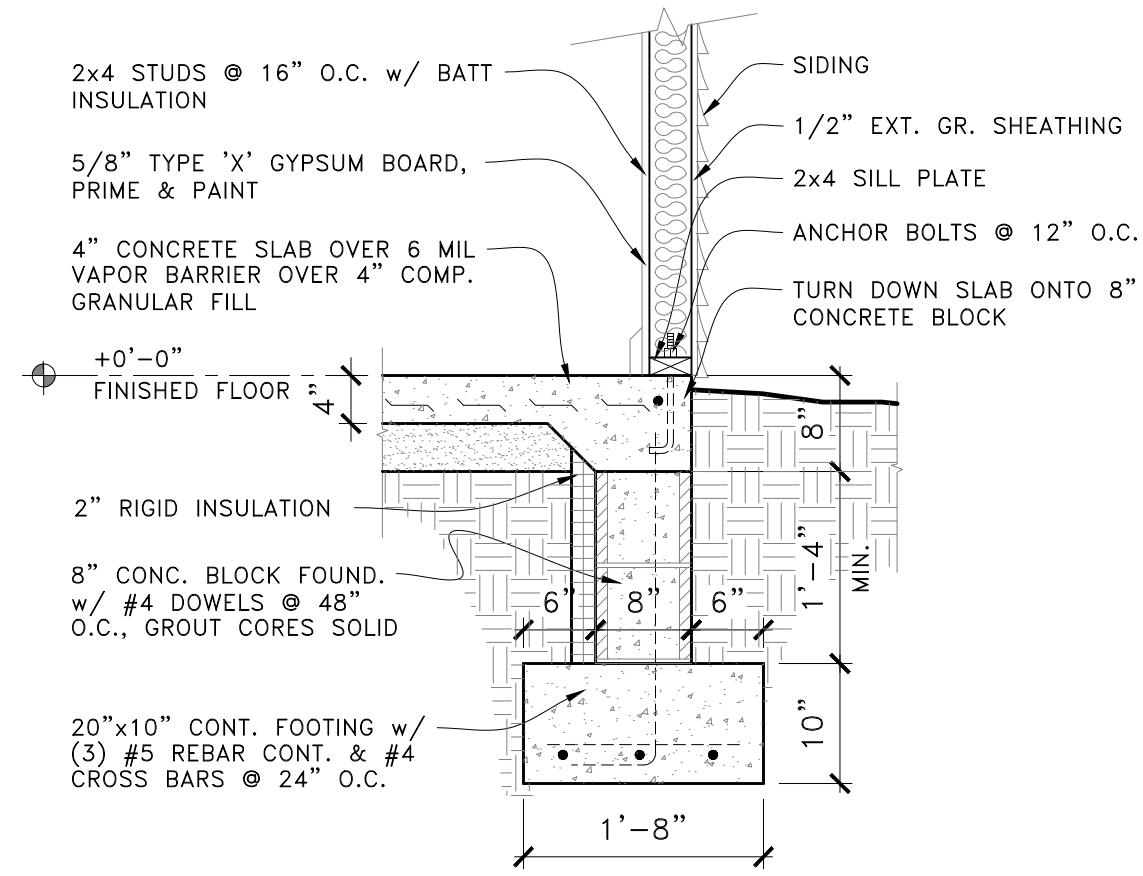
2 THICKENED SLAB @ SANCTUARY WALL
 S1 SCALE: 3/4" = 1'-0" 01



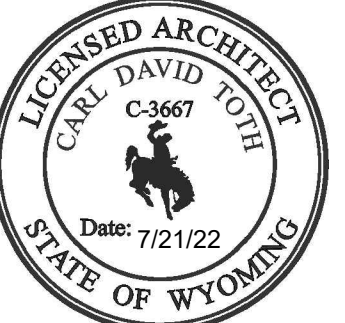
1 ALT. FOUNDATION DETAIL
 S1 SCALE: 3/4" = 1'-0" 01



3 PIER DETAIL AT POST
 S1 SCALE: 3/4" = 1'-0" 01



1 ALT. CMU FOUND. DETAIL
 S1 SCALE: 3/4" = 1'-0" 01



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CODY, WYOMING 82414

SHEET TITLE
ARCH - PLAN -
FLR- 01

SHEET NUMBER

A111

SHEET: OF:

WALL LEGEND

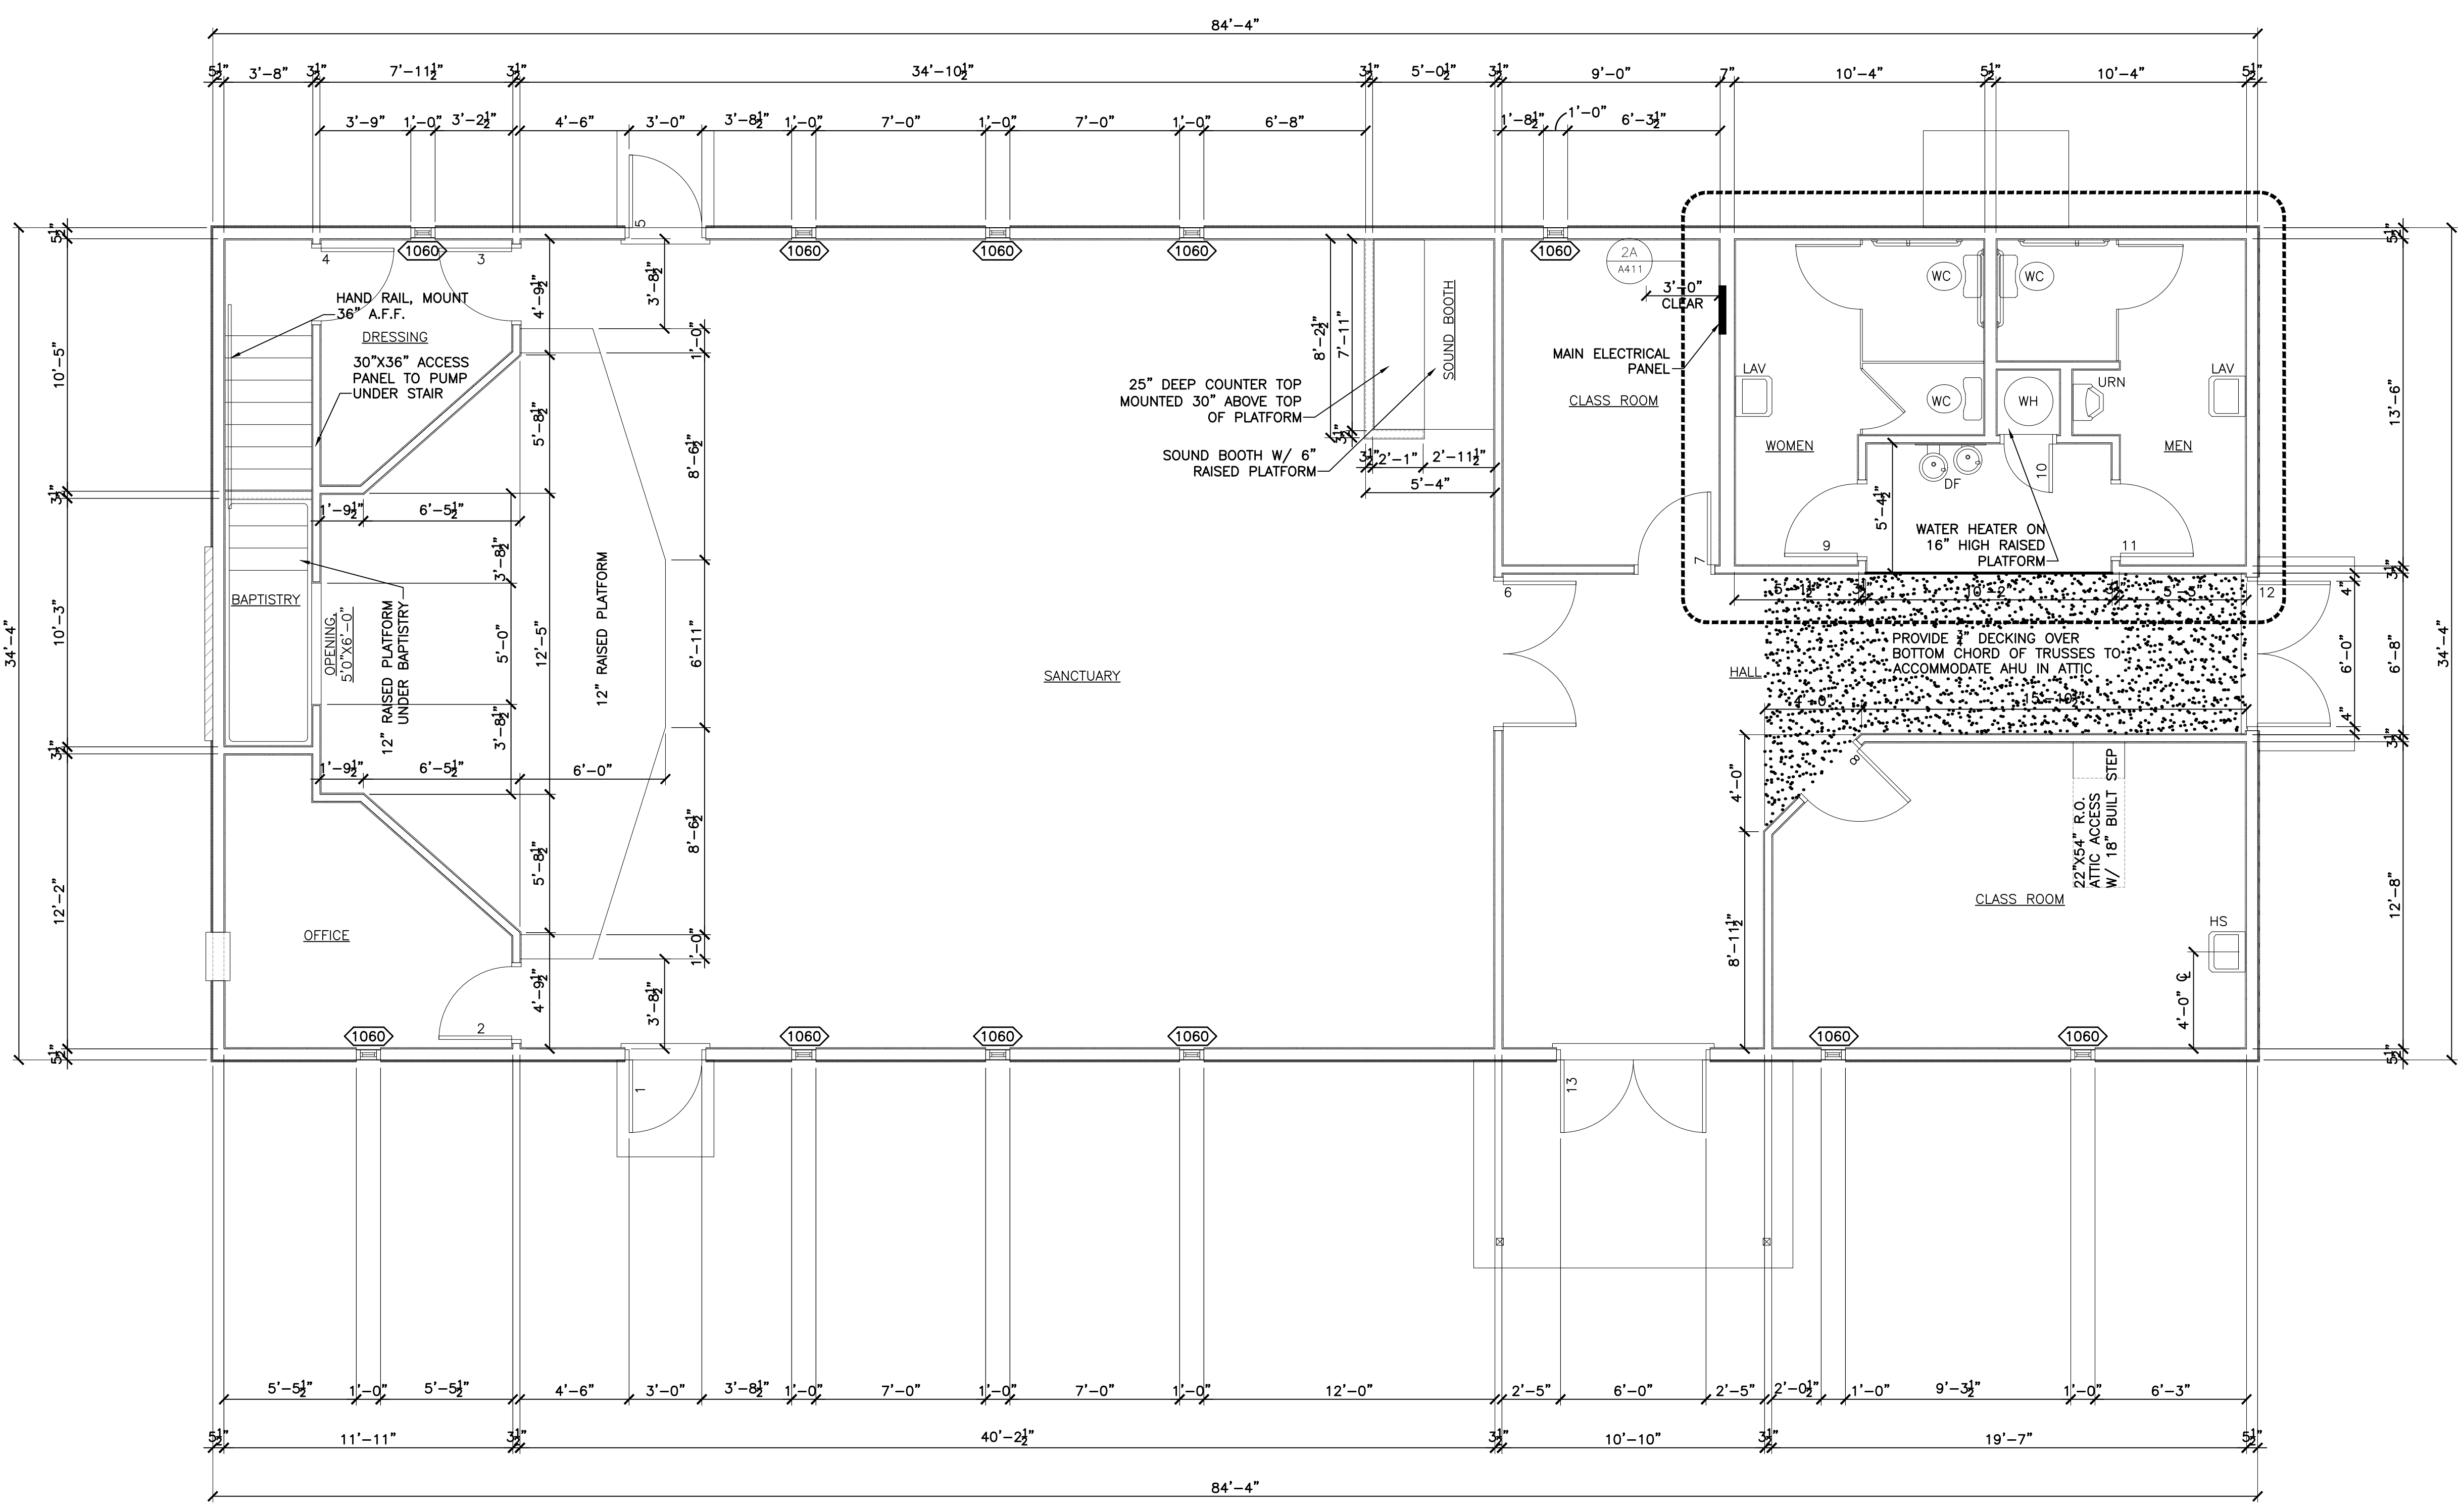
- ==== SOUND BATT INSULATED 2x STUD WALL, SPACE STUDS @ 16" O.C., EXT. WALLS TO BE SHEATH. w/ 7/16" OSB w/ TYVEK V.B. (EXT.) & 5/8" TYPE 'X' GYP. BD. (INT.), INTERIOR WALLS TO RECEIVE 5/8" TYPE 'X' GYP. BD. EACH SIDE.
- ==== SOUND BATT INSULATED 2x6 STUD WALL, SPACE STUDS @ 18" O.C. w/ 5/8" TYPE 'X' GYP. BD. ON EACH SIDE, PRIME & PAINT.
- ==== SOUND BATT INSULATED DOUBLE 2x4 STUD WALL, SPACE STUDS @ 16" O.C. w/ 5/8" TYPE 'X' GYP. BOARD EA. SIDE, PRIME & PAINT.
- ==== PARTITION WALL HEIGHT TO 48" A.F.F.

FLOOR PLAN NOTES:

1. ALL INTERIOR WALLS TO BE COVERED IN 5/8" TYPE 'X' GYPSUM WALL BOARD.
2. CEILING OVER BAPTISTRY AND STAIRS TO RECEIVE 5/8" TYPE 'X' GYPSUM WALL BOARD.
3. OFFICE, CLASSROOMS, RESTROOMS AND HALL TO RECEIVE LAY-IN TILE CEILING, DECK ABOVE TO BE 5/8" TYPE 'X' GWB, TAPED & MUDDED. SANCTUARY TO RECEIVE 5/8" TYPE 'X' GWB TAPED & MUDDED w/ 12"x12" RADAR CONCEALED GRID INSTALLED TIGHT TO CEILING -OR- 12"x12" FIRE RATED CONCEALED RADAR GRID TO BOTTOM OF TRUSSES.
4. EXTERIOR WALLS TO RECEIVE 7/16" OSB w/ TYVEK VAPOR BARR.
5. EXTERIOR WALLS TO RECEIVE MIN. R-11 BATT INSULATION.
6. EXTERIOR WALLS TO RECEIVE VINYL SIDING COVERING.
7. ROOF FRAMING TO BE PRE-ENGINEERED TRUSSES (SEE SHT.)
8. WALL FRAMING - 9'-0" 2x4 STUDS @ 16" O.C.
9. ALL DOORS TO BE LABELED 20 MINUTE DOORS w/ HINGE CLOSERS ON CLASSROOM DOORS & LCN SMOOTHIE CLOSER ON SANCTUARY AND RESTROOM INTERIOR DOORS.

PLUMBING LEGEND

- DF - DRINKING FOUNTAIN
- HS - HAND SINK
- LAV - LAVATORY
- URN - URINAL
- WC - WATER CLOSET



2A
FIRST FLOOR
PLAN
1/4"=1' 4' 6'
1:48

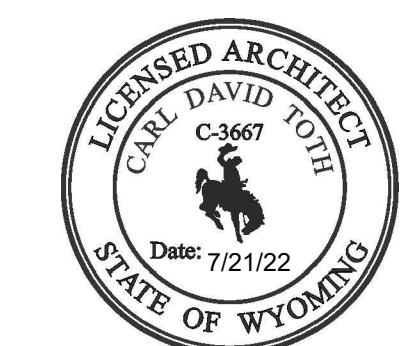
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MARK	DATE, INIT., DESCRIPTION

C

PROJECT TITLE

B

CIAD - WYOMING
 5 NEX PERCE DRIVE
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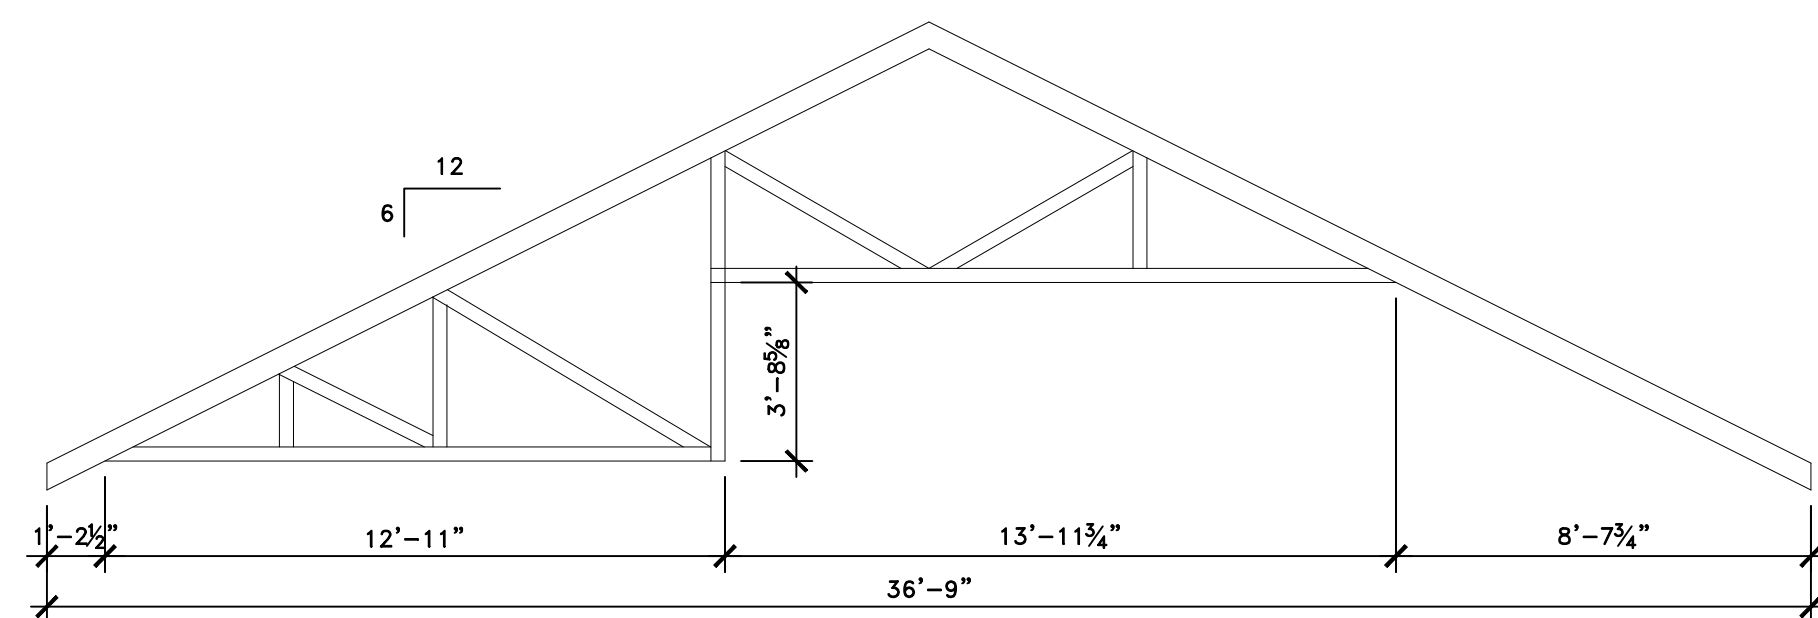
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 ARCH - PLAN -
 ROOF

SHEET NUMBER

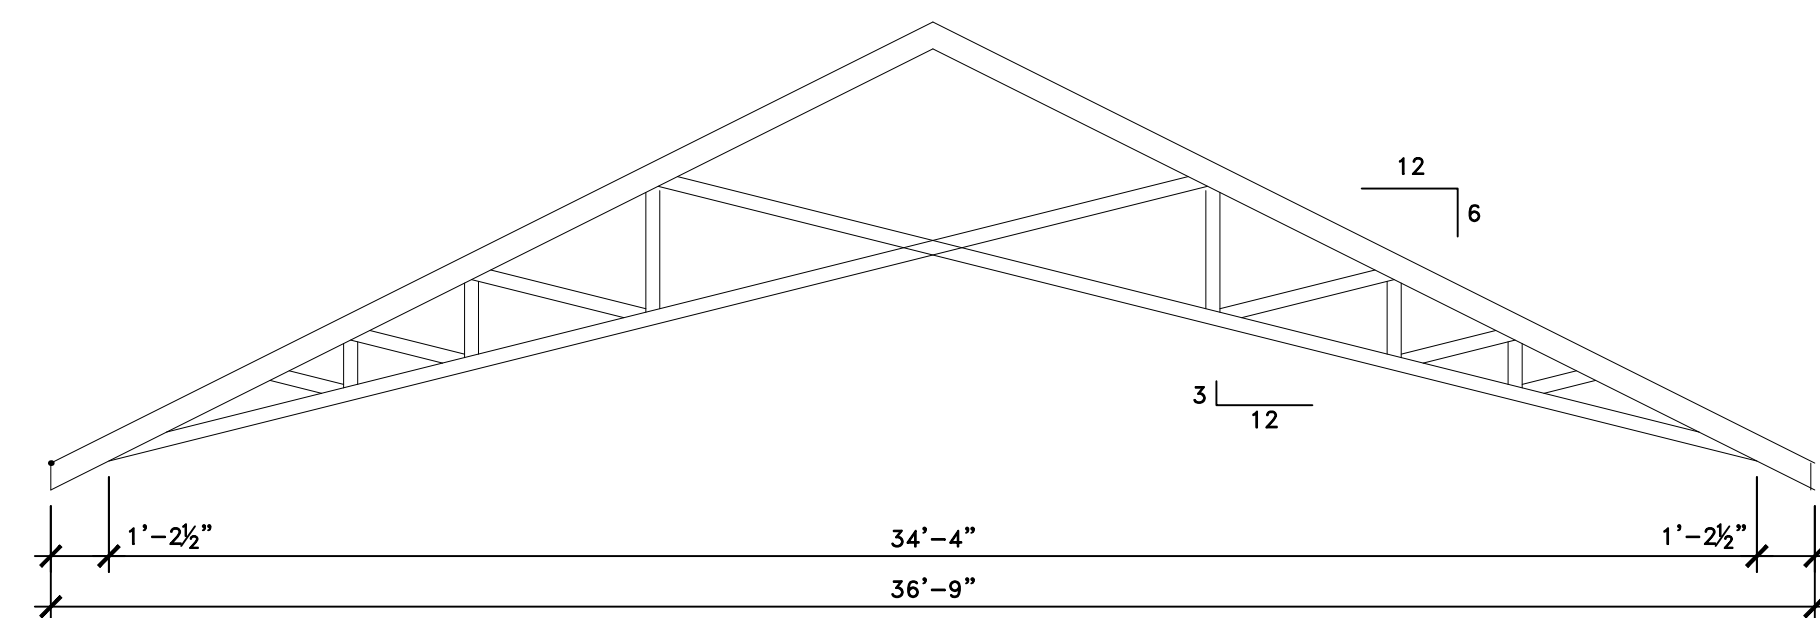
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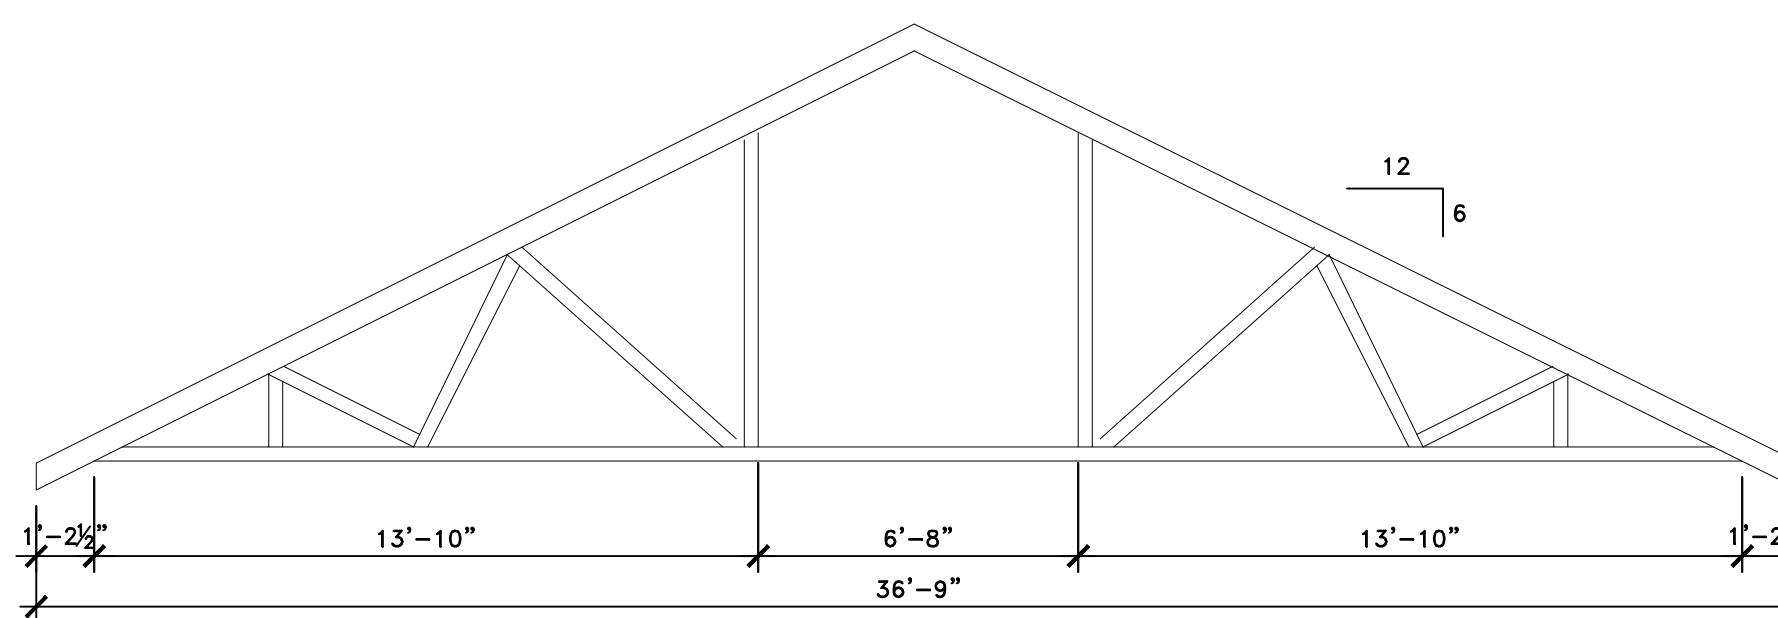
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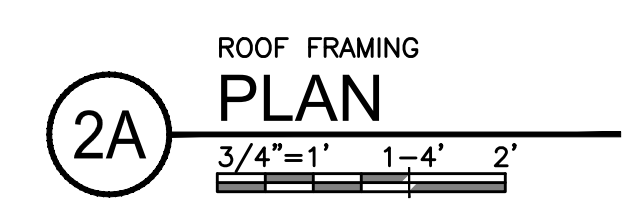
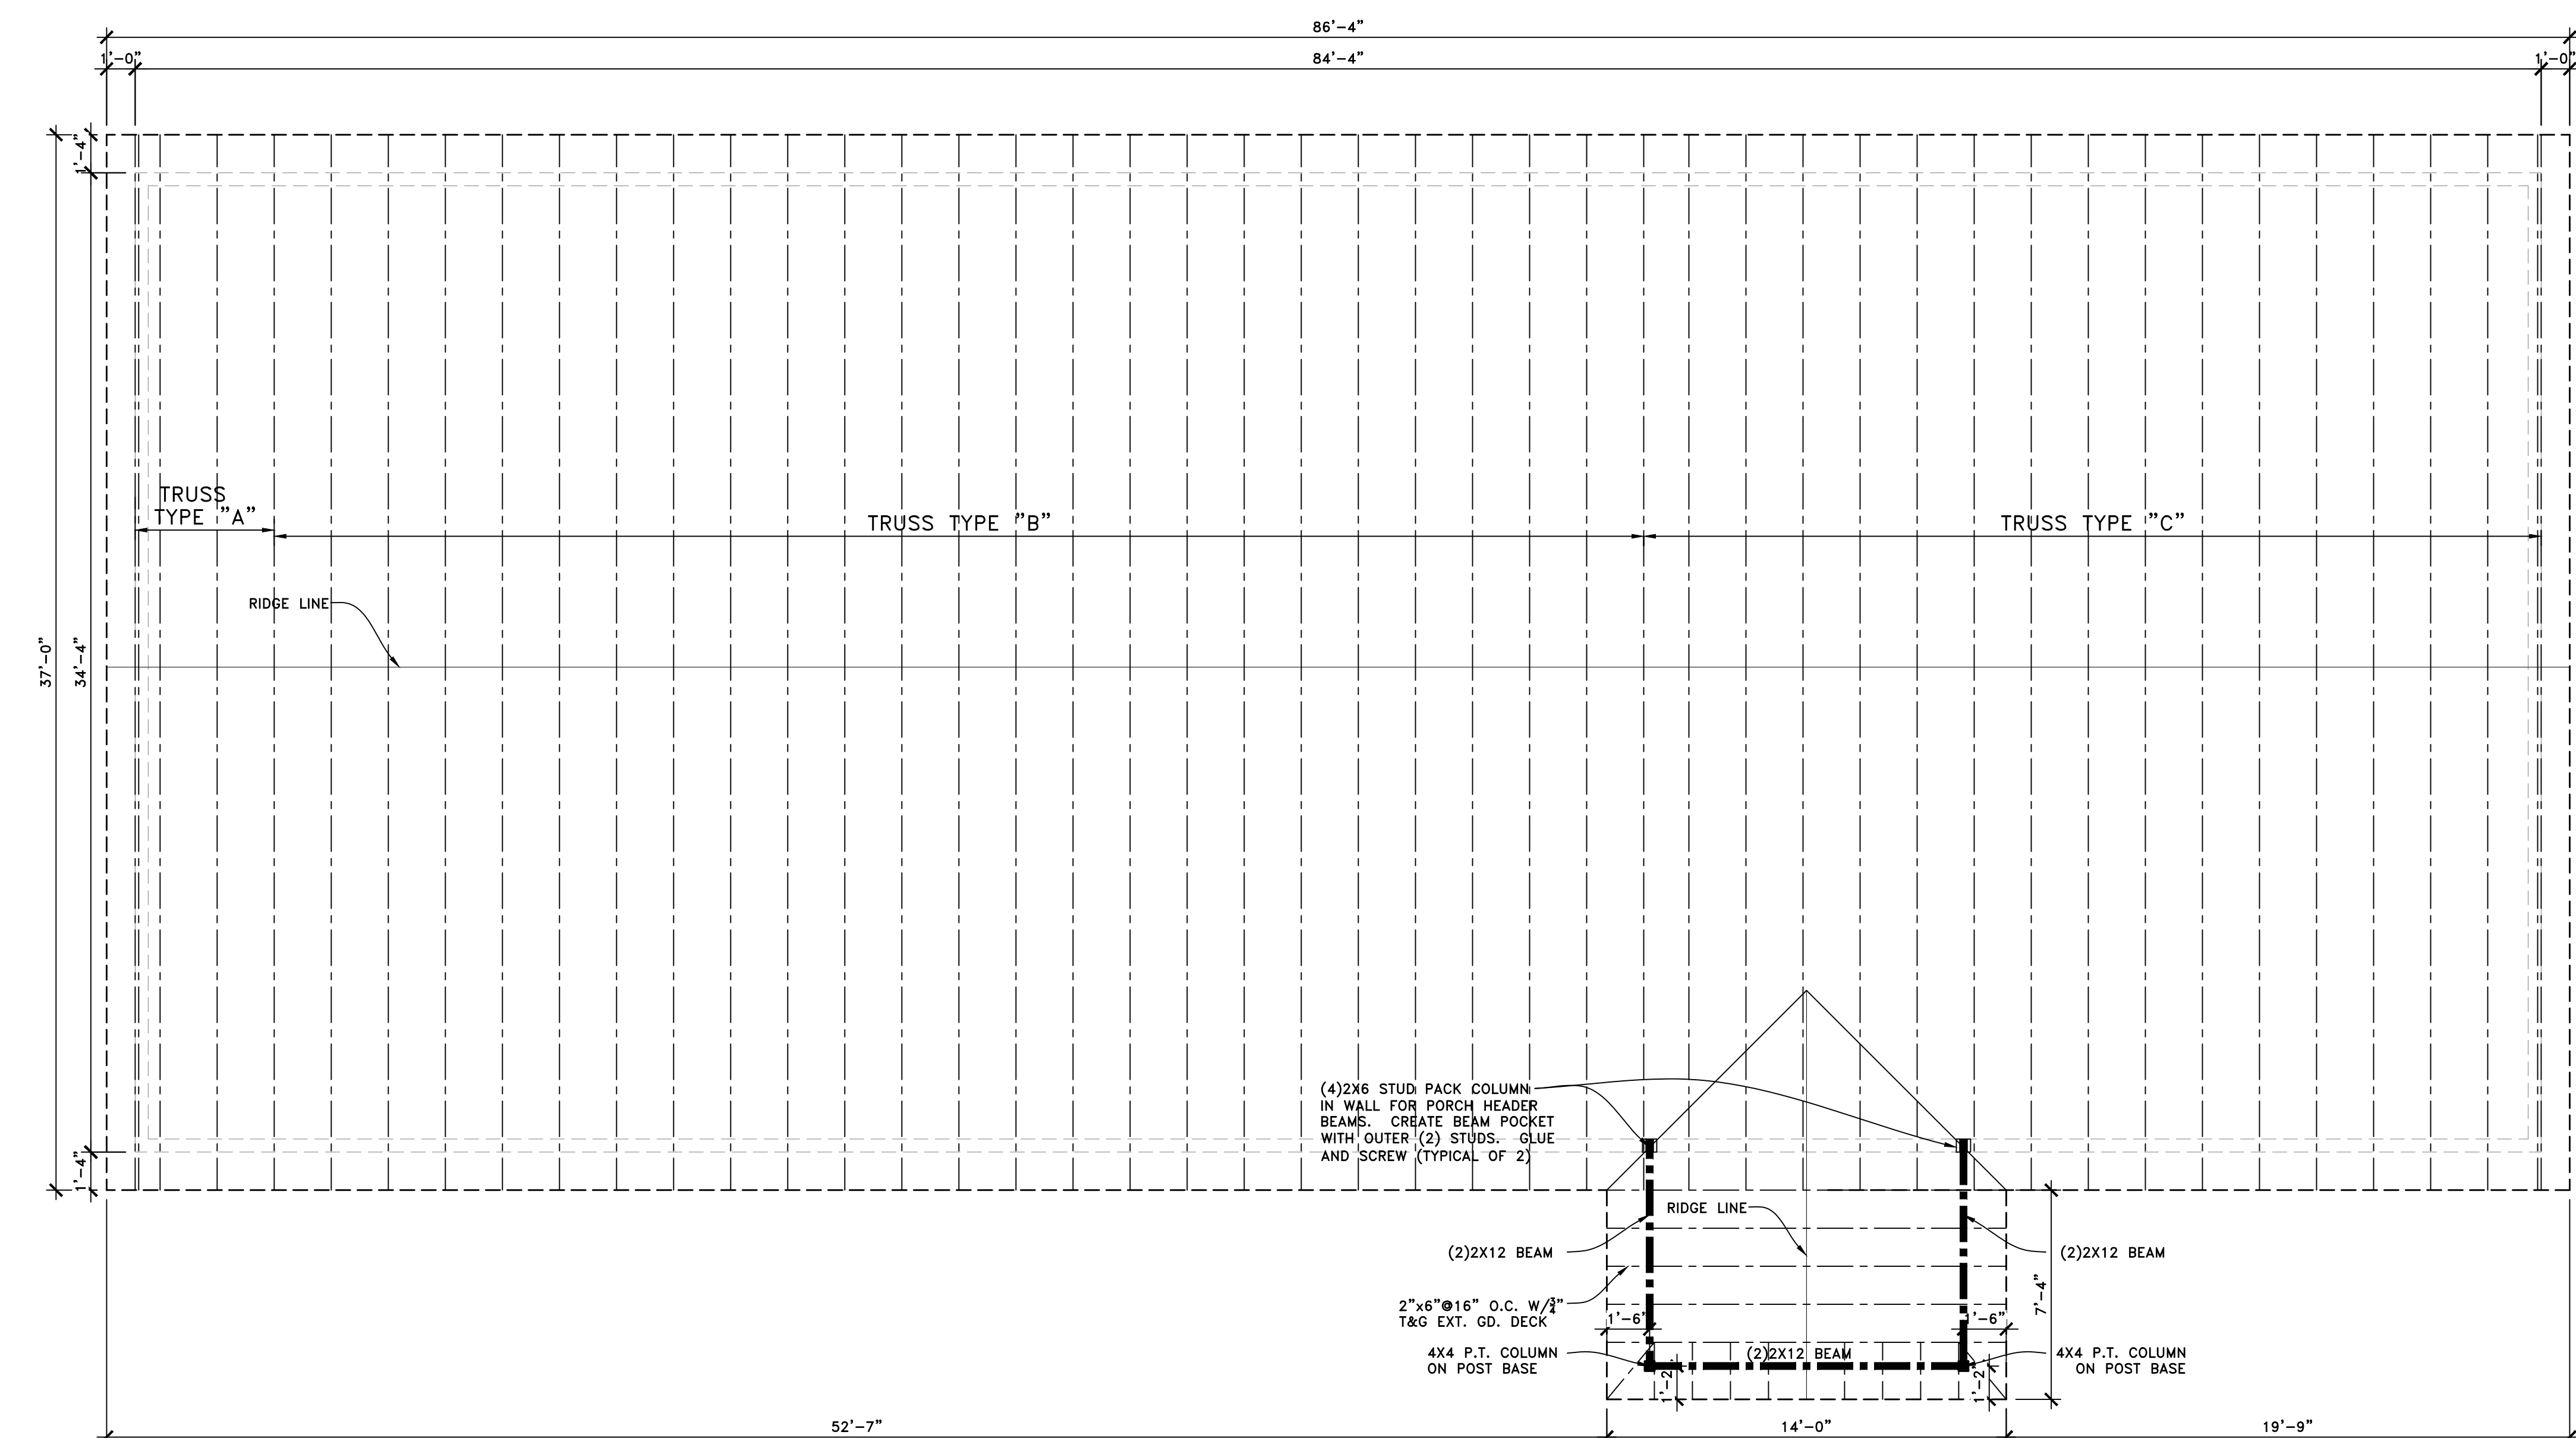
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TRUSS B




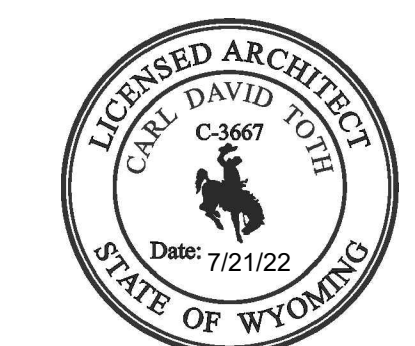
TRUSS C



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DATE: 07/21/2022
 PROJECT NO.: 22075
 CAD PLATFORM: ACA 2023
 PLOT REF. NO.: SEE LOWER LEFT
 DRAWING SCALE: SEE DRAWING

REVISIONS

MARK	DATE	INIT.	DESCRIPTION

C

PROJECT TITLE

CIAD - WYOMING
 5 NEX PERCE DRIVE
 CODY, WYOMING 82414

B

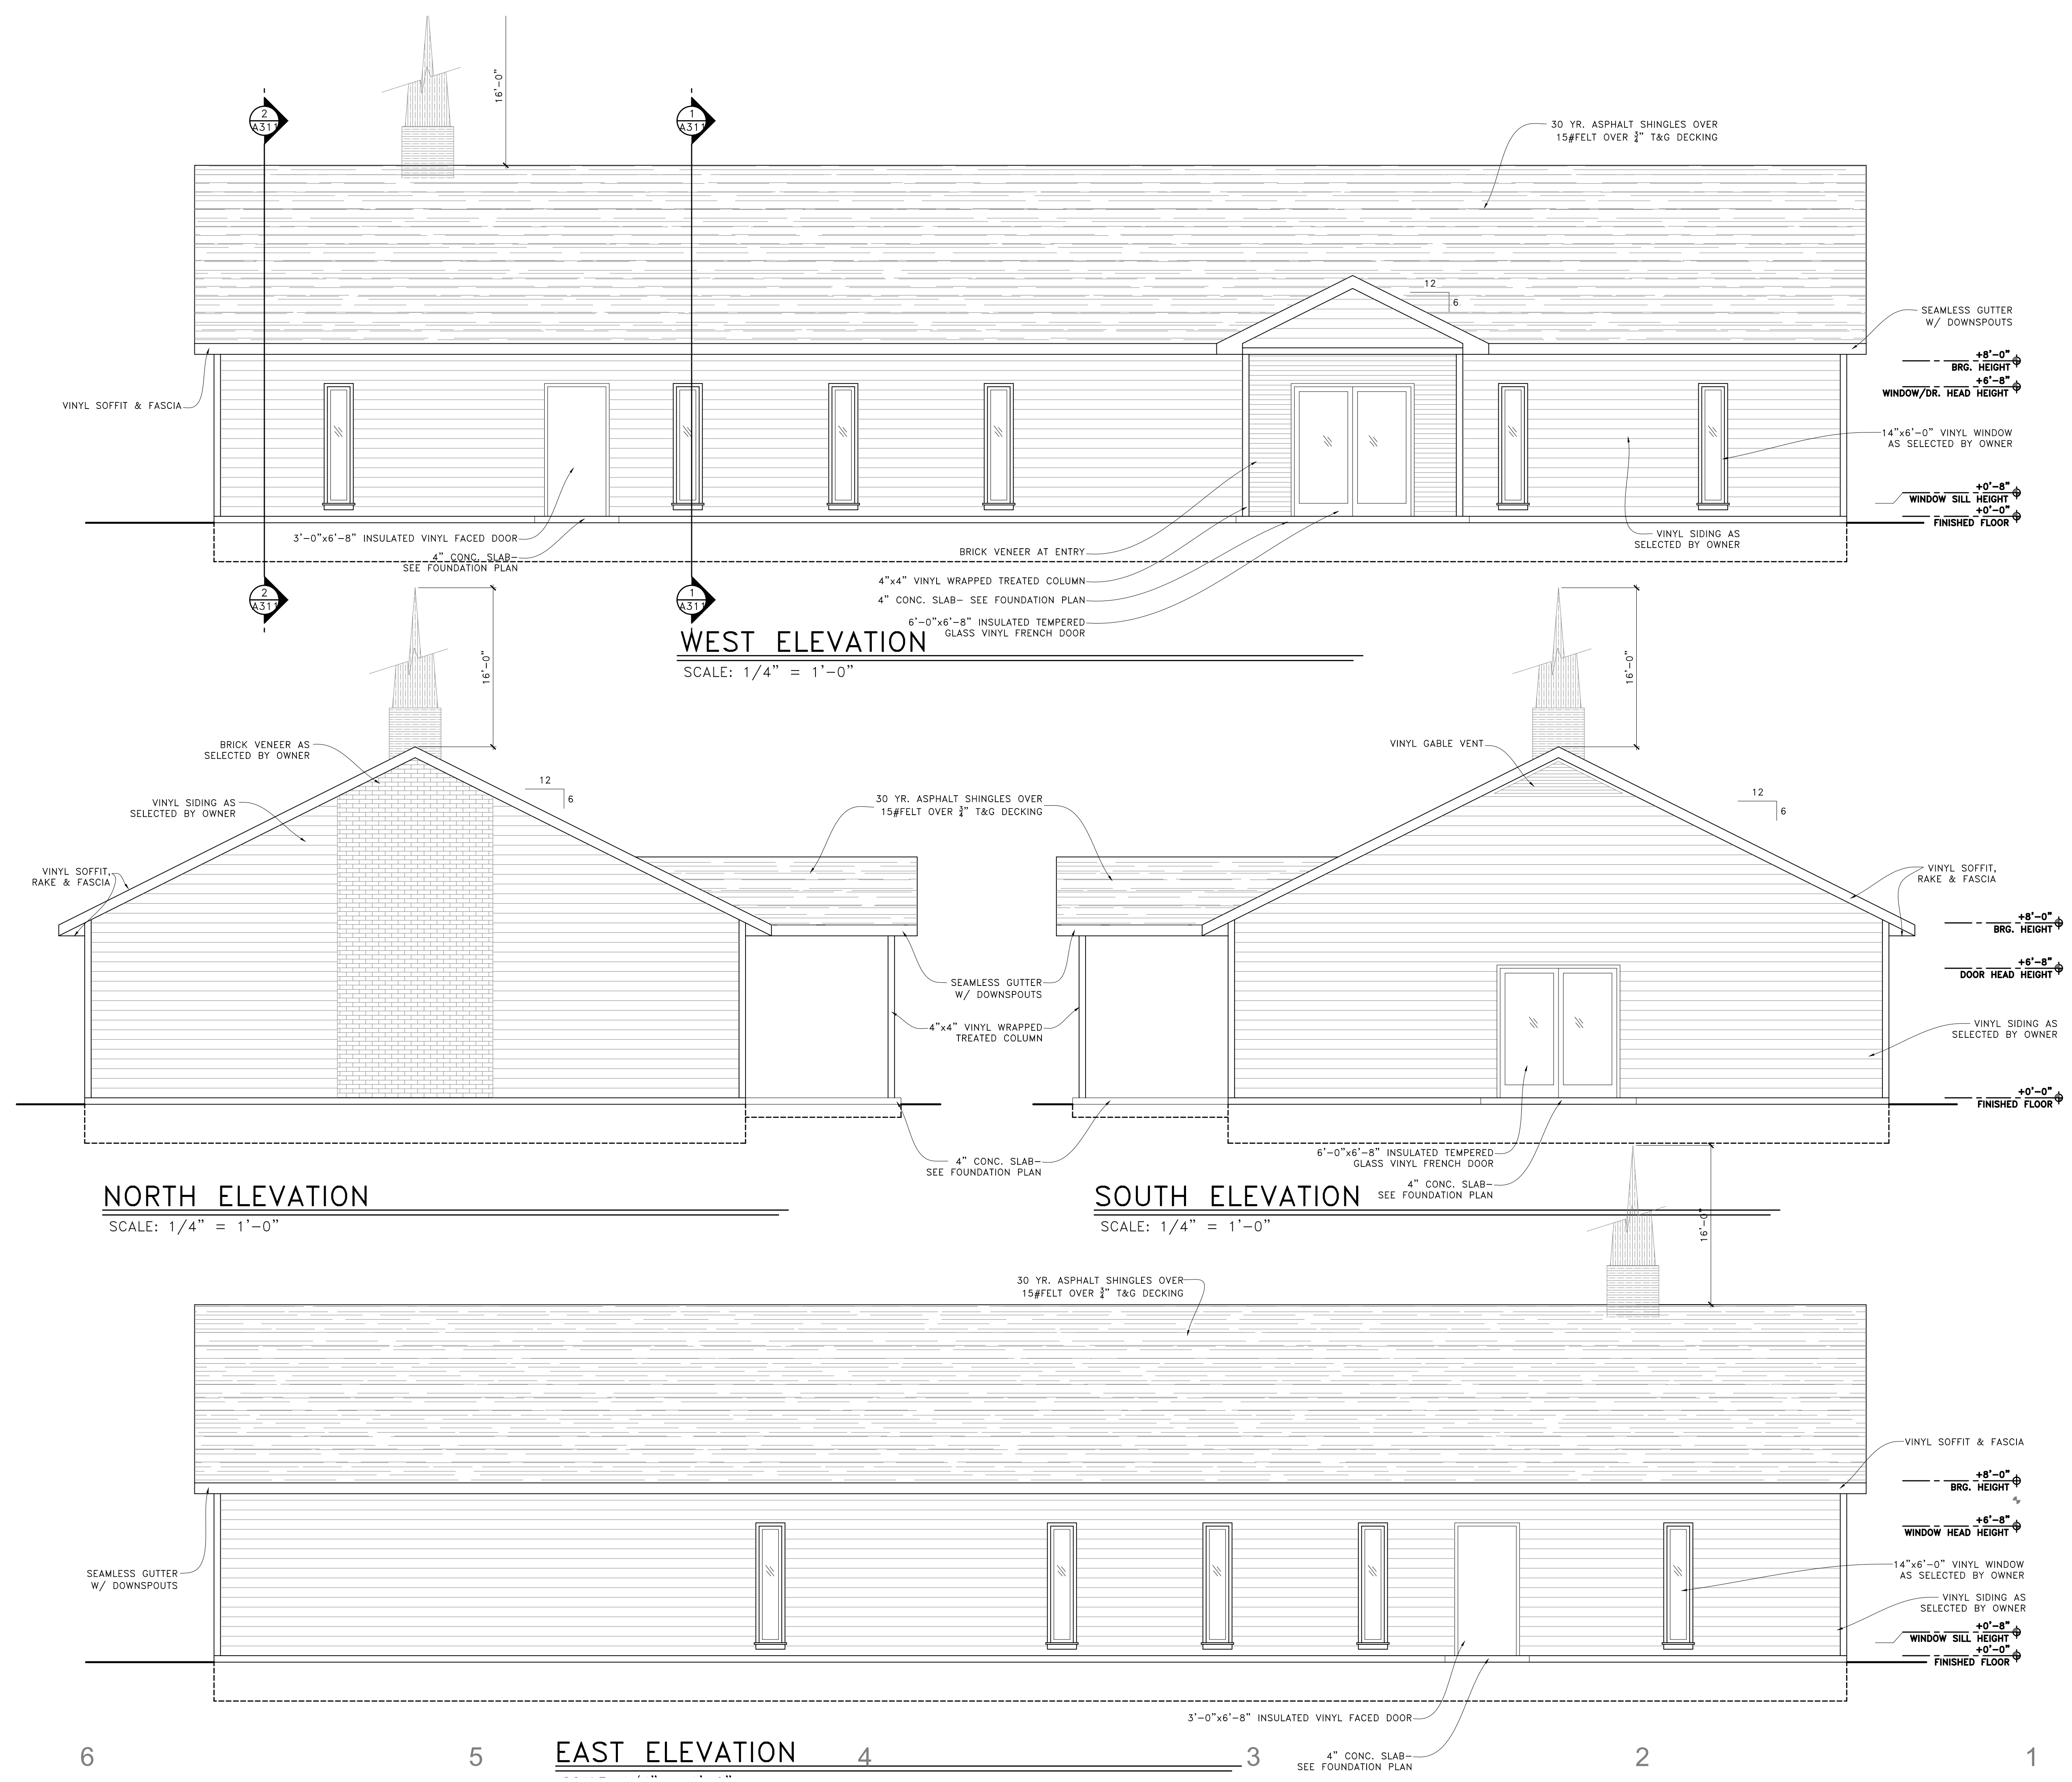
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 ARCH - ELEV -
 EXTR

A

SHEET NUMBER

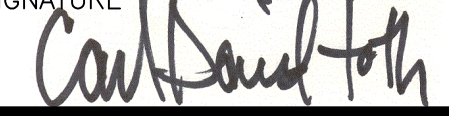
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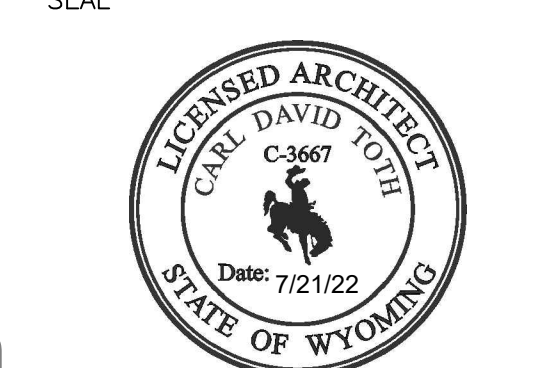
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REVISIONS

MARK	DATE	INIT.	DESCRIPTION

PROJECT TITLE

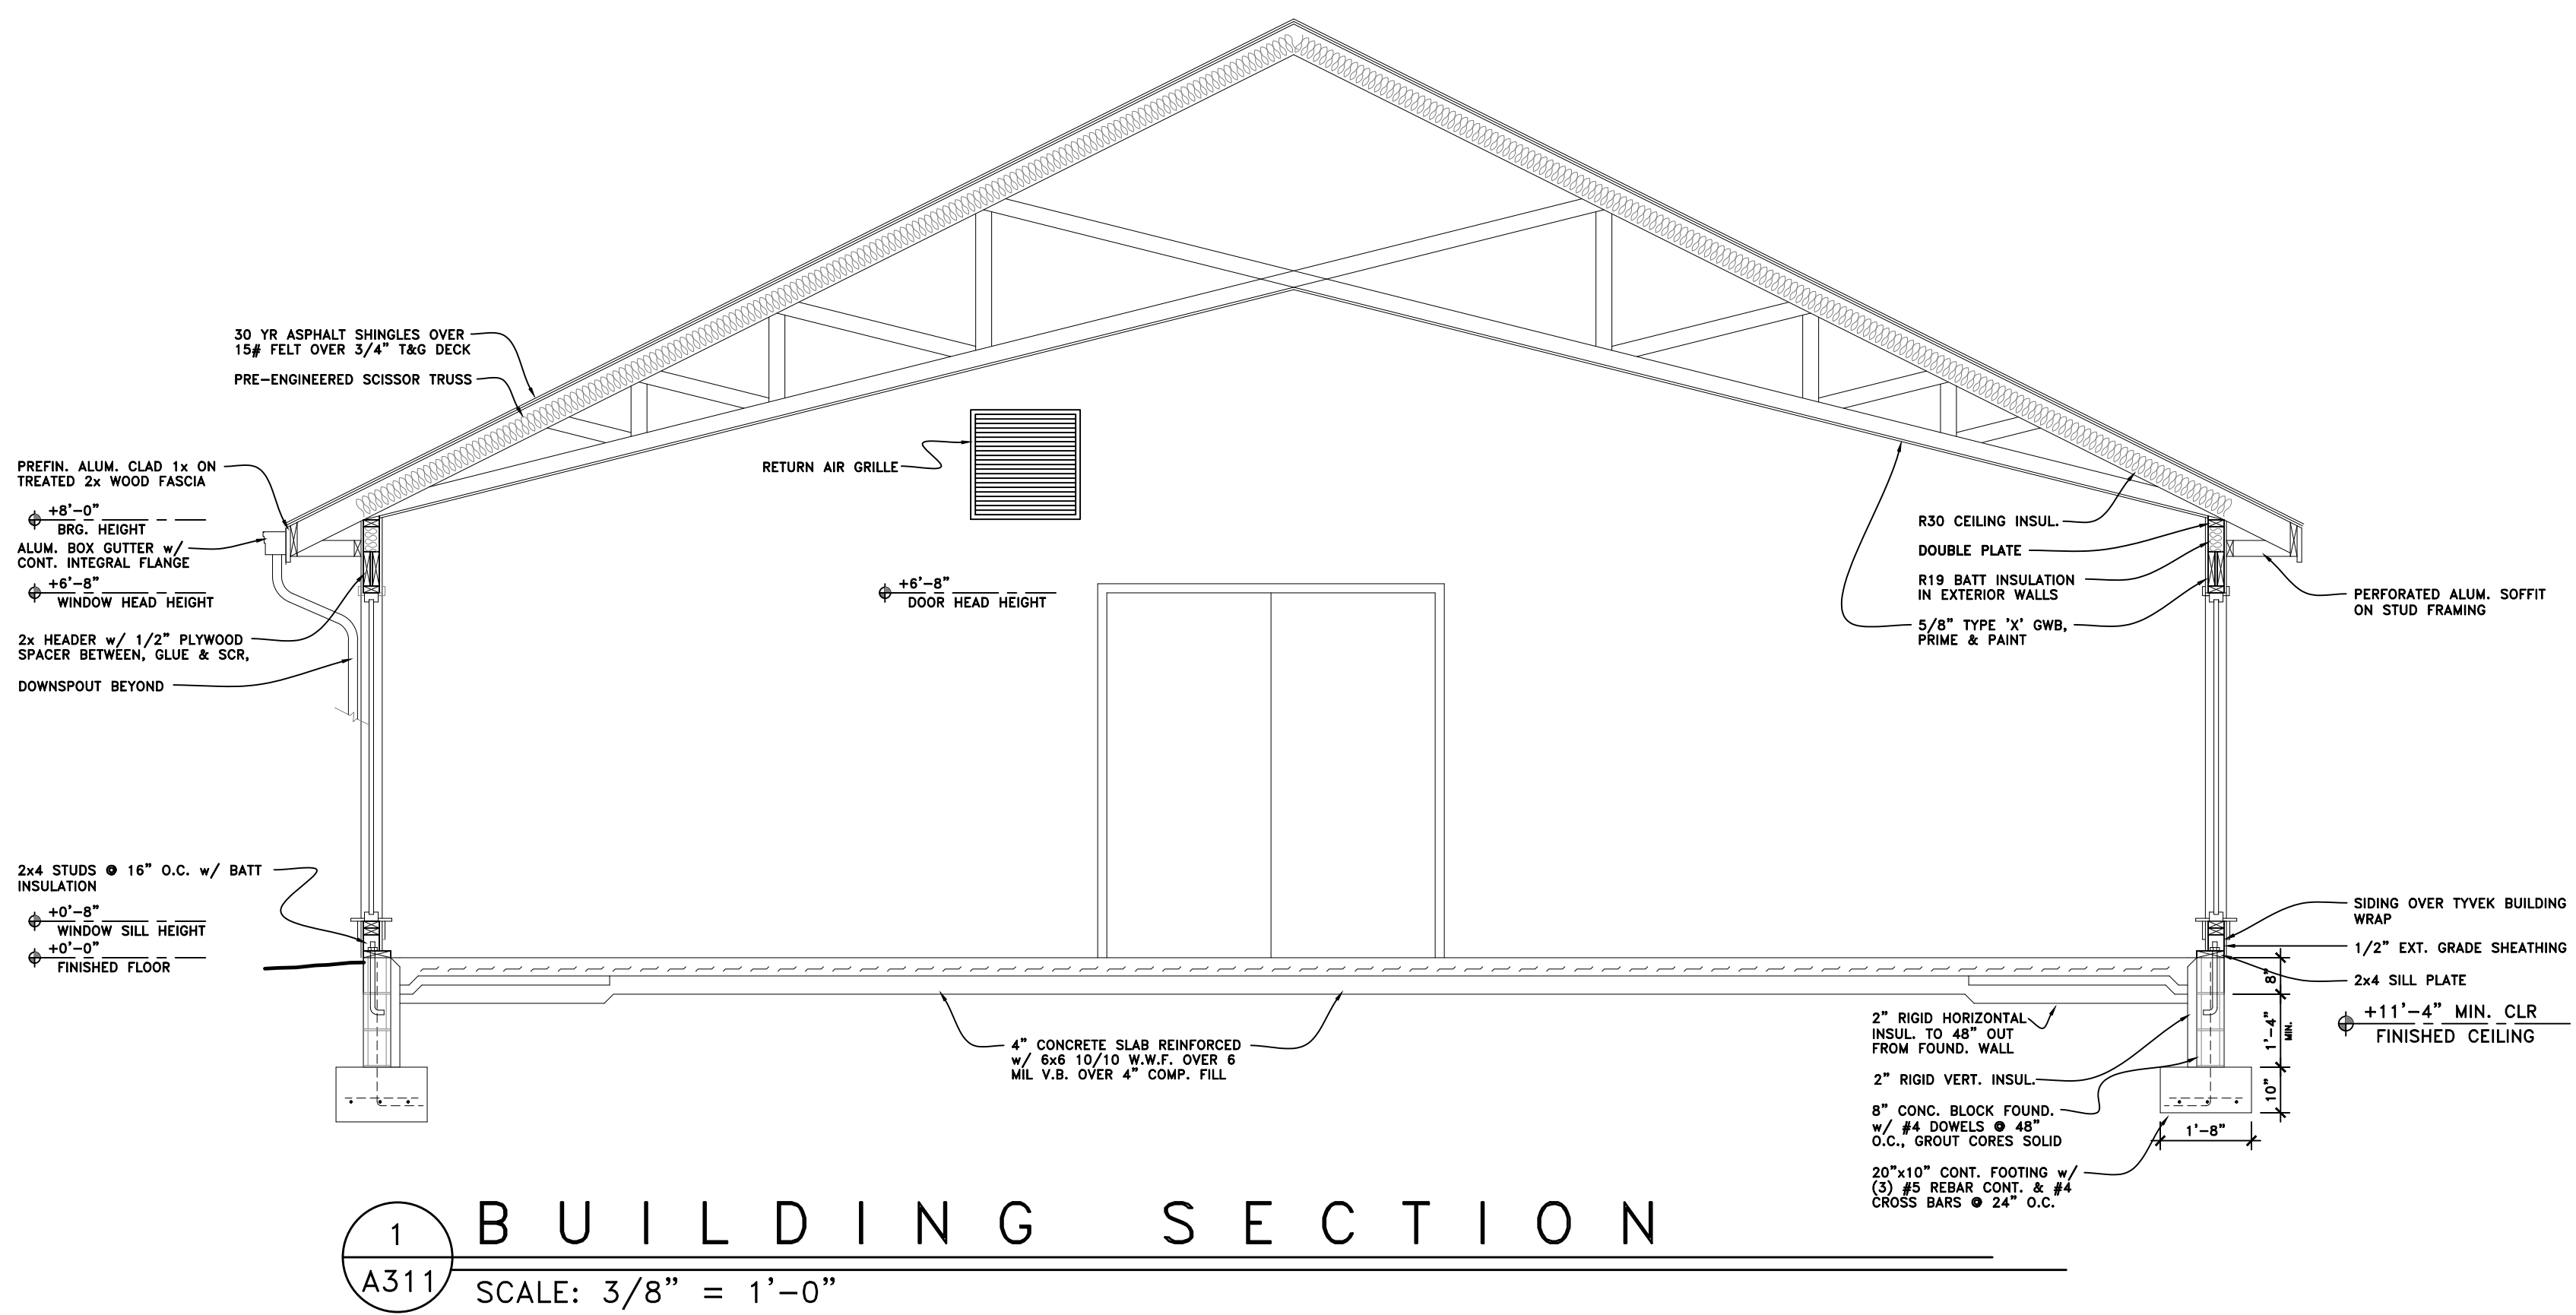
CIAD - WYOMING
 5 NEX PERCE DRIVE
 CODY, WYOMING 82414

SHEET TITLE
 ARCH - SECT - WALL

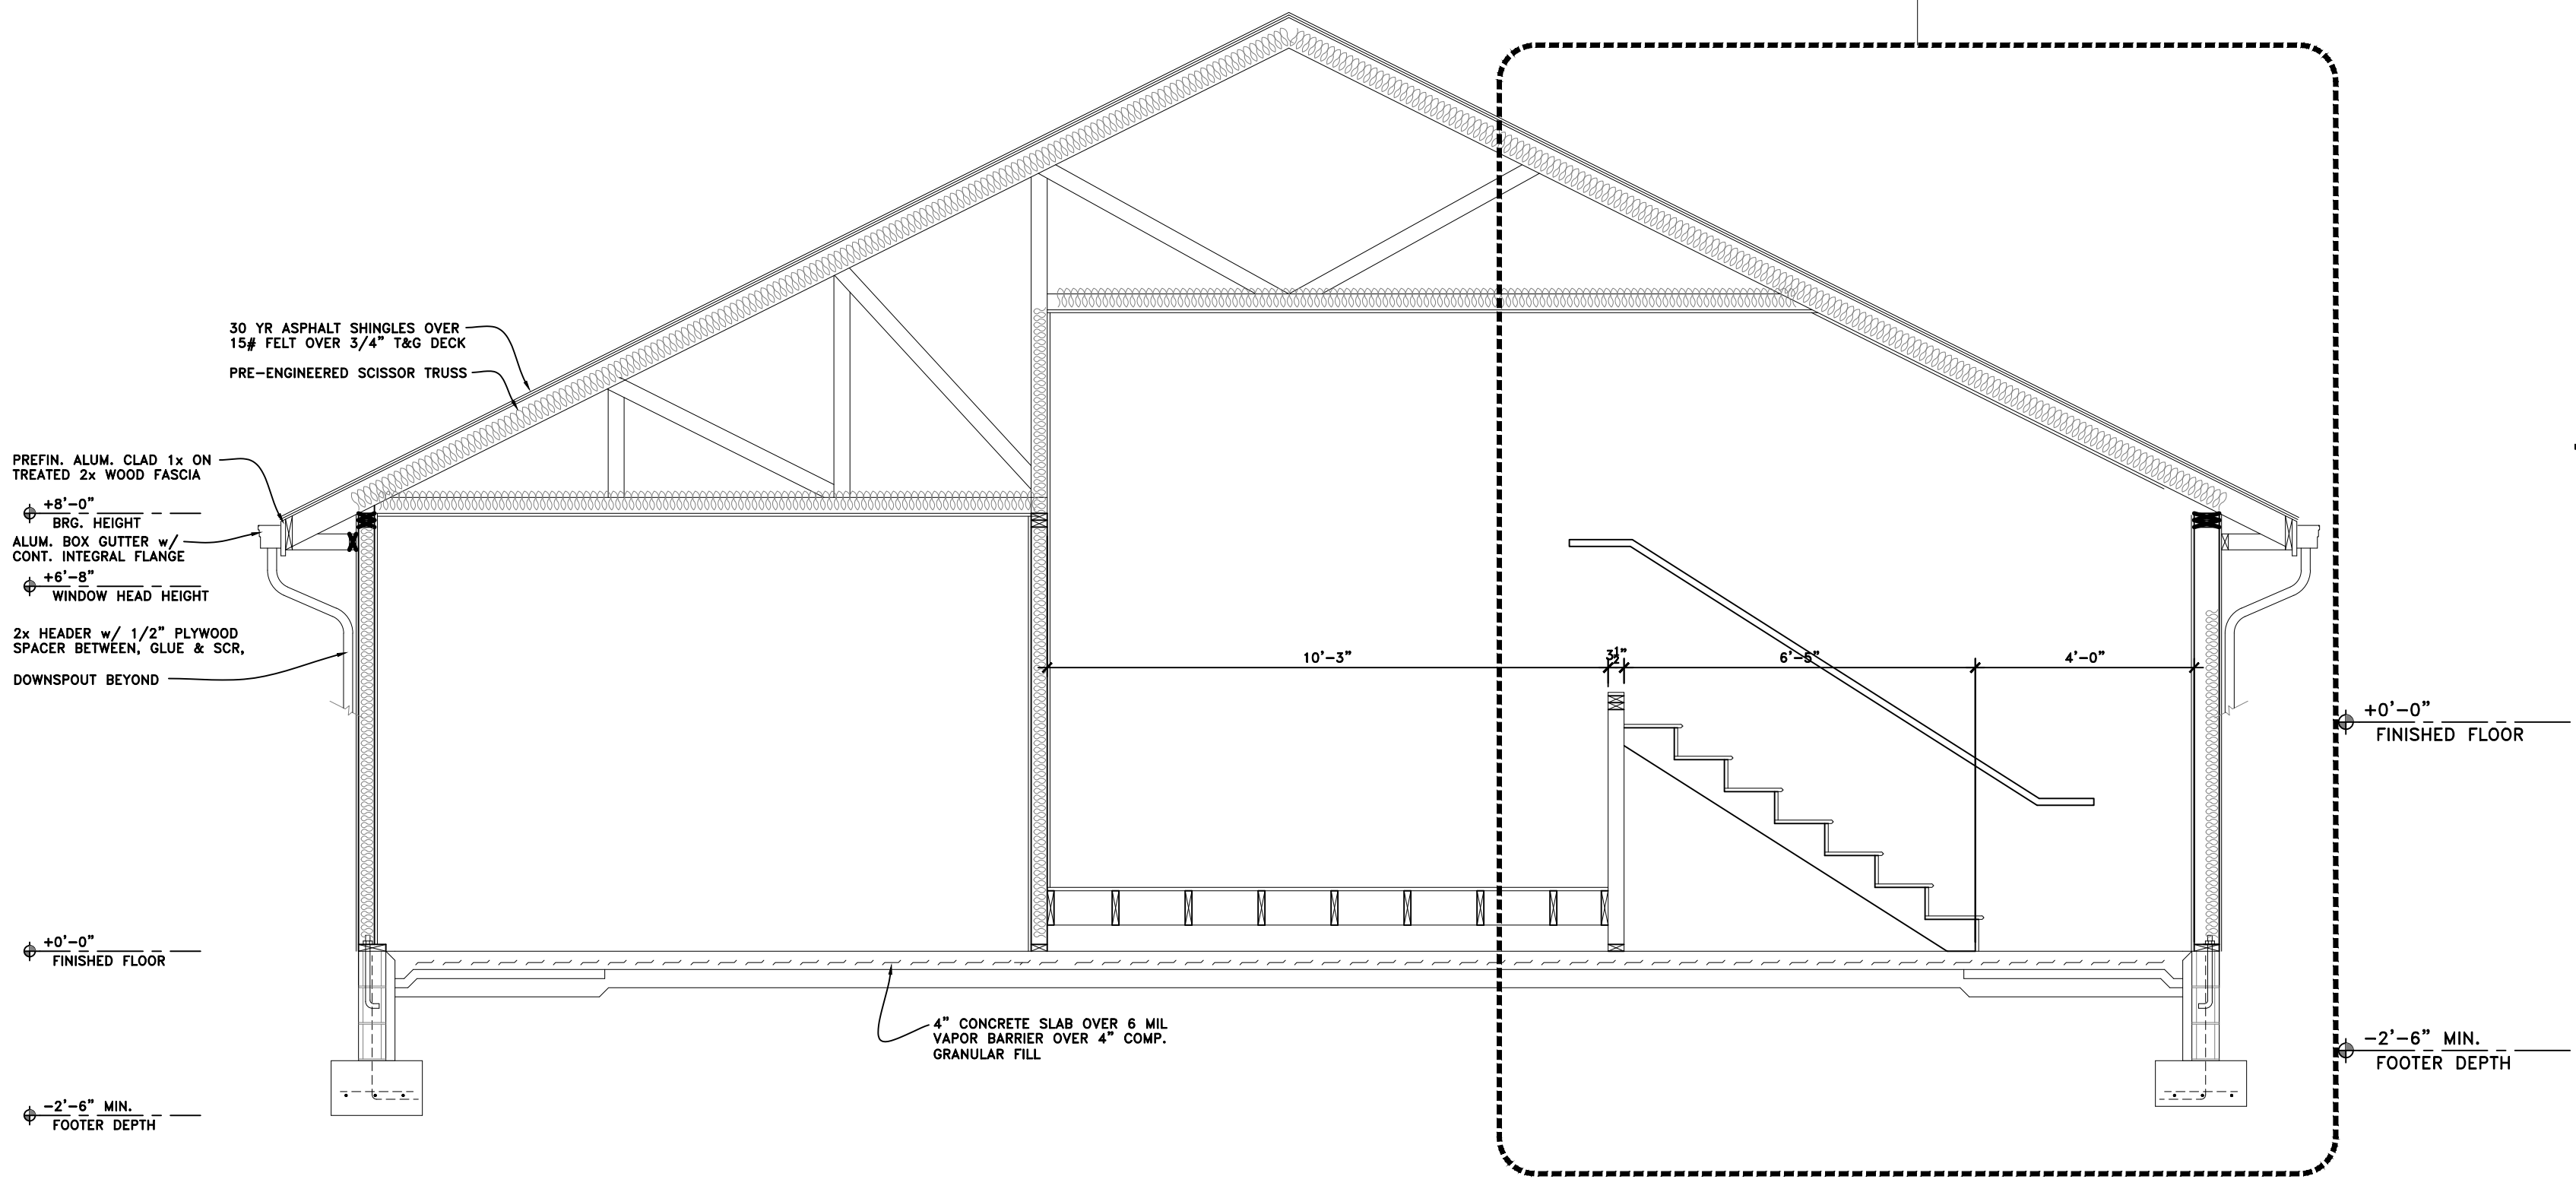
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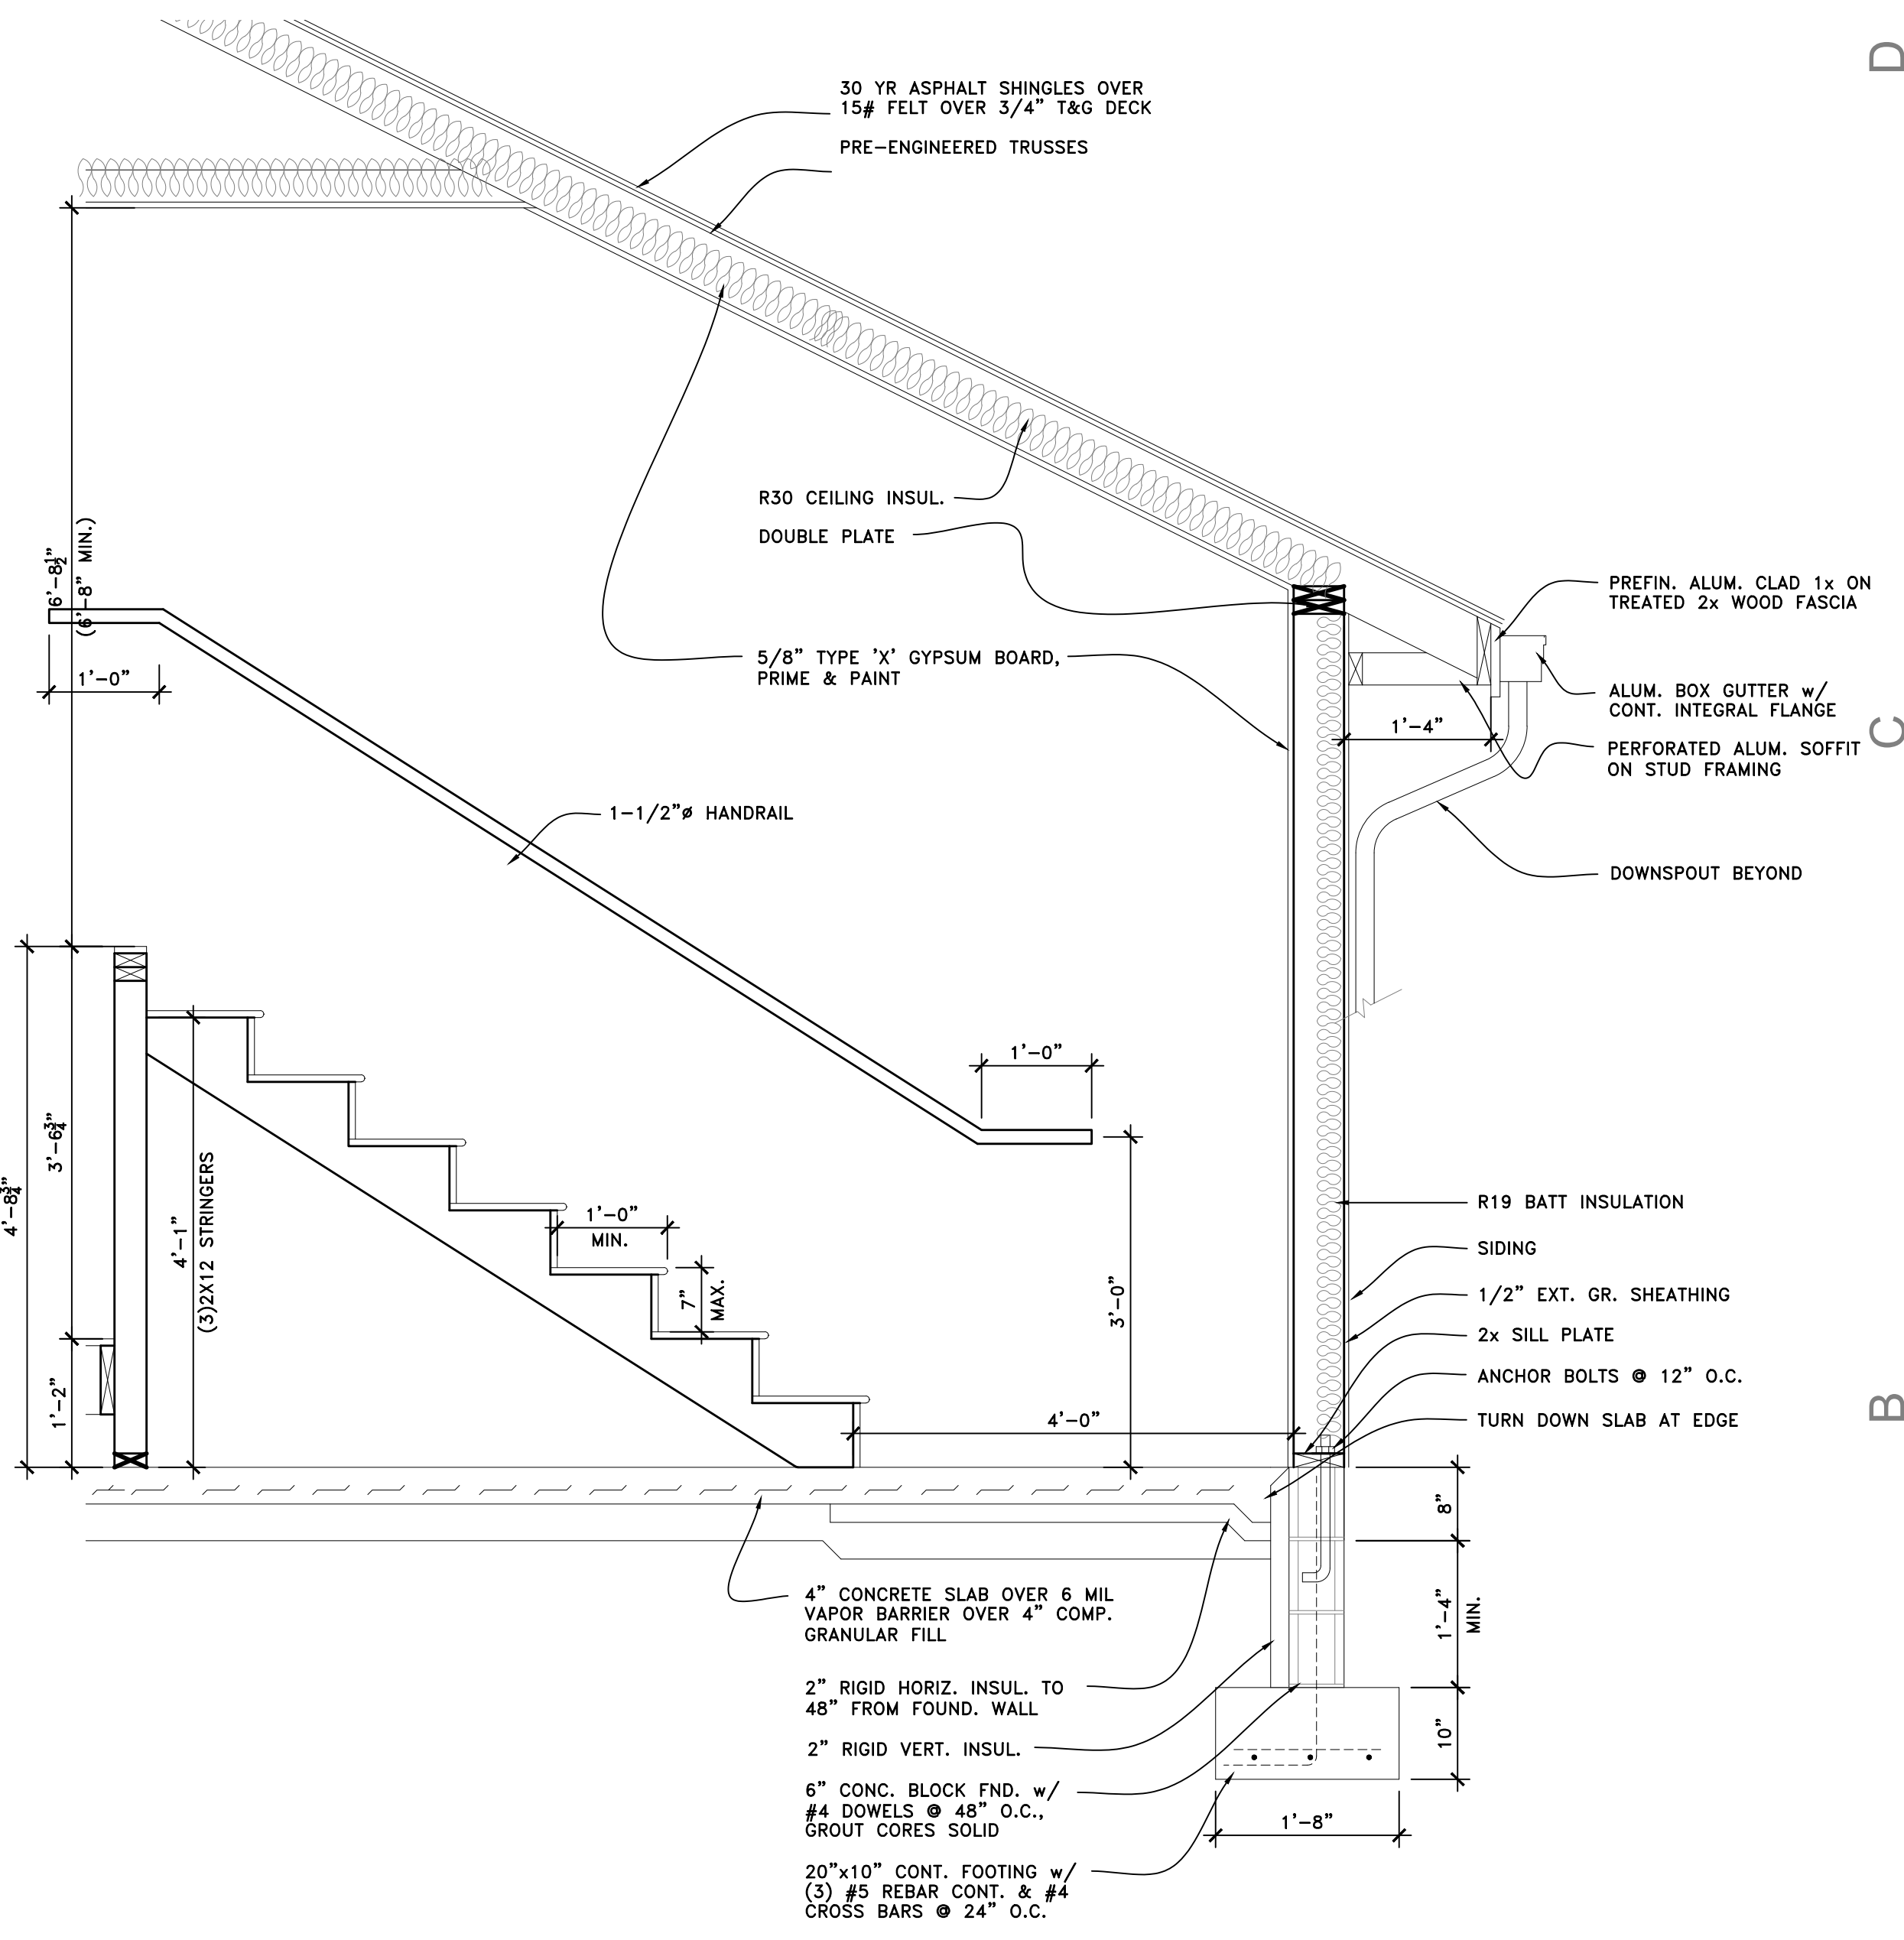
SHEET: OF:



1 BUILDING SECTION
 A311 SCALE: 3/8" = 1'-0"



2 BUILDING SECTION
 A311 SCALE: 3/8" = 1'-0"

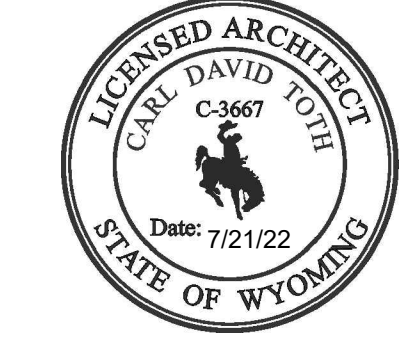


3 ENLARGED SECTION
 A311 SCALE: 3/4" = 1'-0"

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REVISIONS	
MARK	DATE / INIT. / DESCRIPTION

PROJECT TITLE

CIAD - WYOMING
5 NEX PERCE DRIVE
CODY, WYOMING 82414

SHEET TITLE
ARCH - PLAN -
ENLARGED

SHEET NUMBER

A411

SHEET: OF:

WALL LEGEND

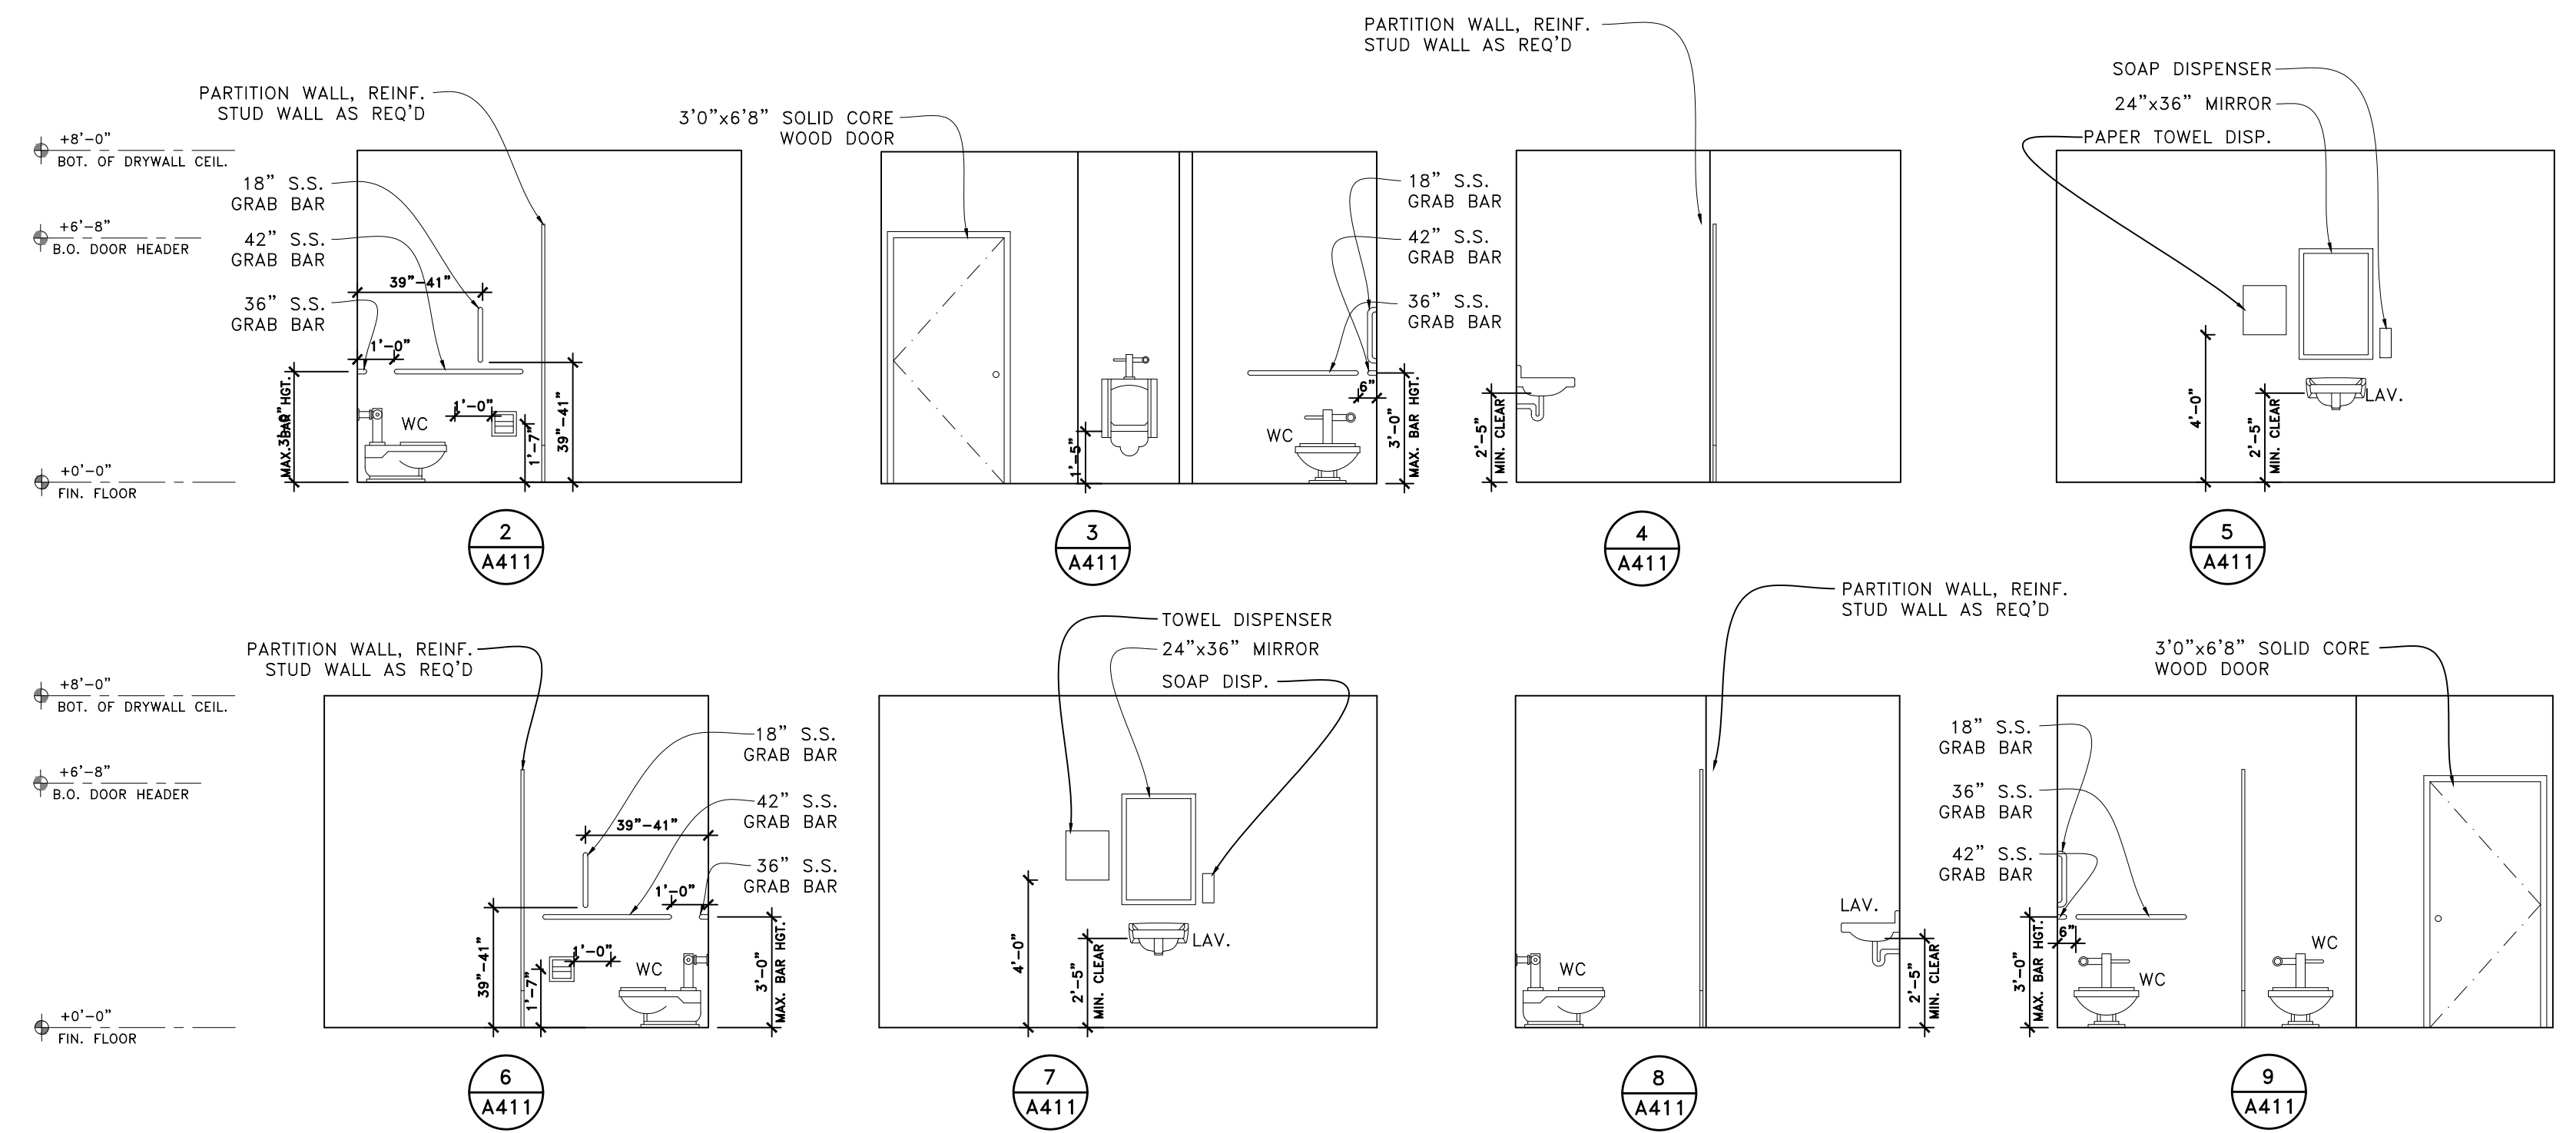
- SOUND BATT INSULATED 2x STUD WALL, SPACE STUDS @ 16" O.C., EXT. WALLS TO BE SHEATH. w/ 7/16" OSB w/ TYVEK V.B. (EXT.) & 5/8" TYPE 'X' GYP. BD. (INT.). INTERIOR WALLS TO RECEIVE 5/8" TYPE 'X' GYP. BD. EACH SIDE.
- SOUND BATT INSULATED 2x6 STUD WALL, SPACE STUDS @ 16" O.C. w/ 5/8" TYPE 'X' GYP. BD. ON EACH SIDE, PRIME & PAINT.
- SOUND BATT INSULATED DOUBLE 2x4 STUD WALL, SPACE STUDS @ 16" O.C. w/ 5/8" TYPE 'X' GYP. BOARD EA. SIDE, PRIME & PAINT.
- PARTITION WALL HEIGHT TO 48" A.F.F.

FLOOR PLAN NOTES:

1. ALL INTERIOR WALLS TO BE COVERED IN 5/8" TYPE 'X' GYPSUM WALL BOARD.
2. CEILING OVER BAPTISTRY AND STAIRS TO RECEIVE 5/8" TYPE 'X' GYPSUM WALL BOARD.
3. OFFICE, CLASSROOMS, RESTROOMS AND HALL TO RECEIVE LAY-IN TILE CEILING, DECK ABOVE TO BE 5/8" TYPE 'X' GWB, TAPED & MUDDED. SANCTUARY TO RECEIVE 5/8" TYPE 'X' GWB TAPED & MUDDED w/ 12"x12" RADAR CONCEALED GRID INSTALLED TIGHT TO CEILING -OR- 12"x12" FIRE RATED CONCEALED RADAR GRID TO BOTTOM OF TRUSSES.
4. EXTERIOR WALLS TO RECEIVE 7/16" OSB w/ TYVEK VAPOR BARR.
5. EXTERIOR WALLS TO RECEIVE MIN. R-11 BATT INSULATION.
6. EXTERIOR WALLS TO RECEIVE VINYL SIDING COVERING.
7. ROOF FRAMING TO BE PRE-ENGINEERED TRUSSES (SEE SHT.)
8. WALL FRAMING - 9'-0" 2x4 STUDS @ 16" O.C.
9. ALL DOORS TO BE LABELED 20 MINUTE DOORS w/ HINGE CLOSERS ON CLASSROOM DOORS & LCN SMOOTHIE CLOSER ON SANCTUARY AND RESTROOM INTERIOR DOORS.

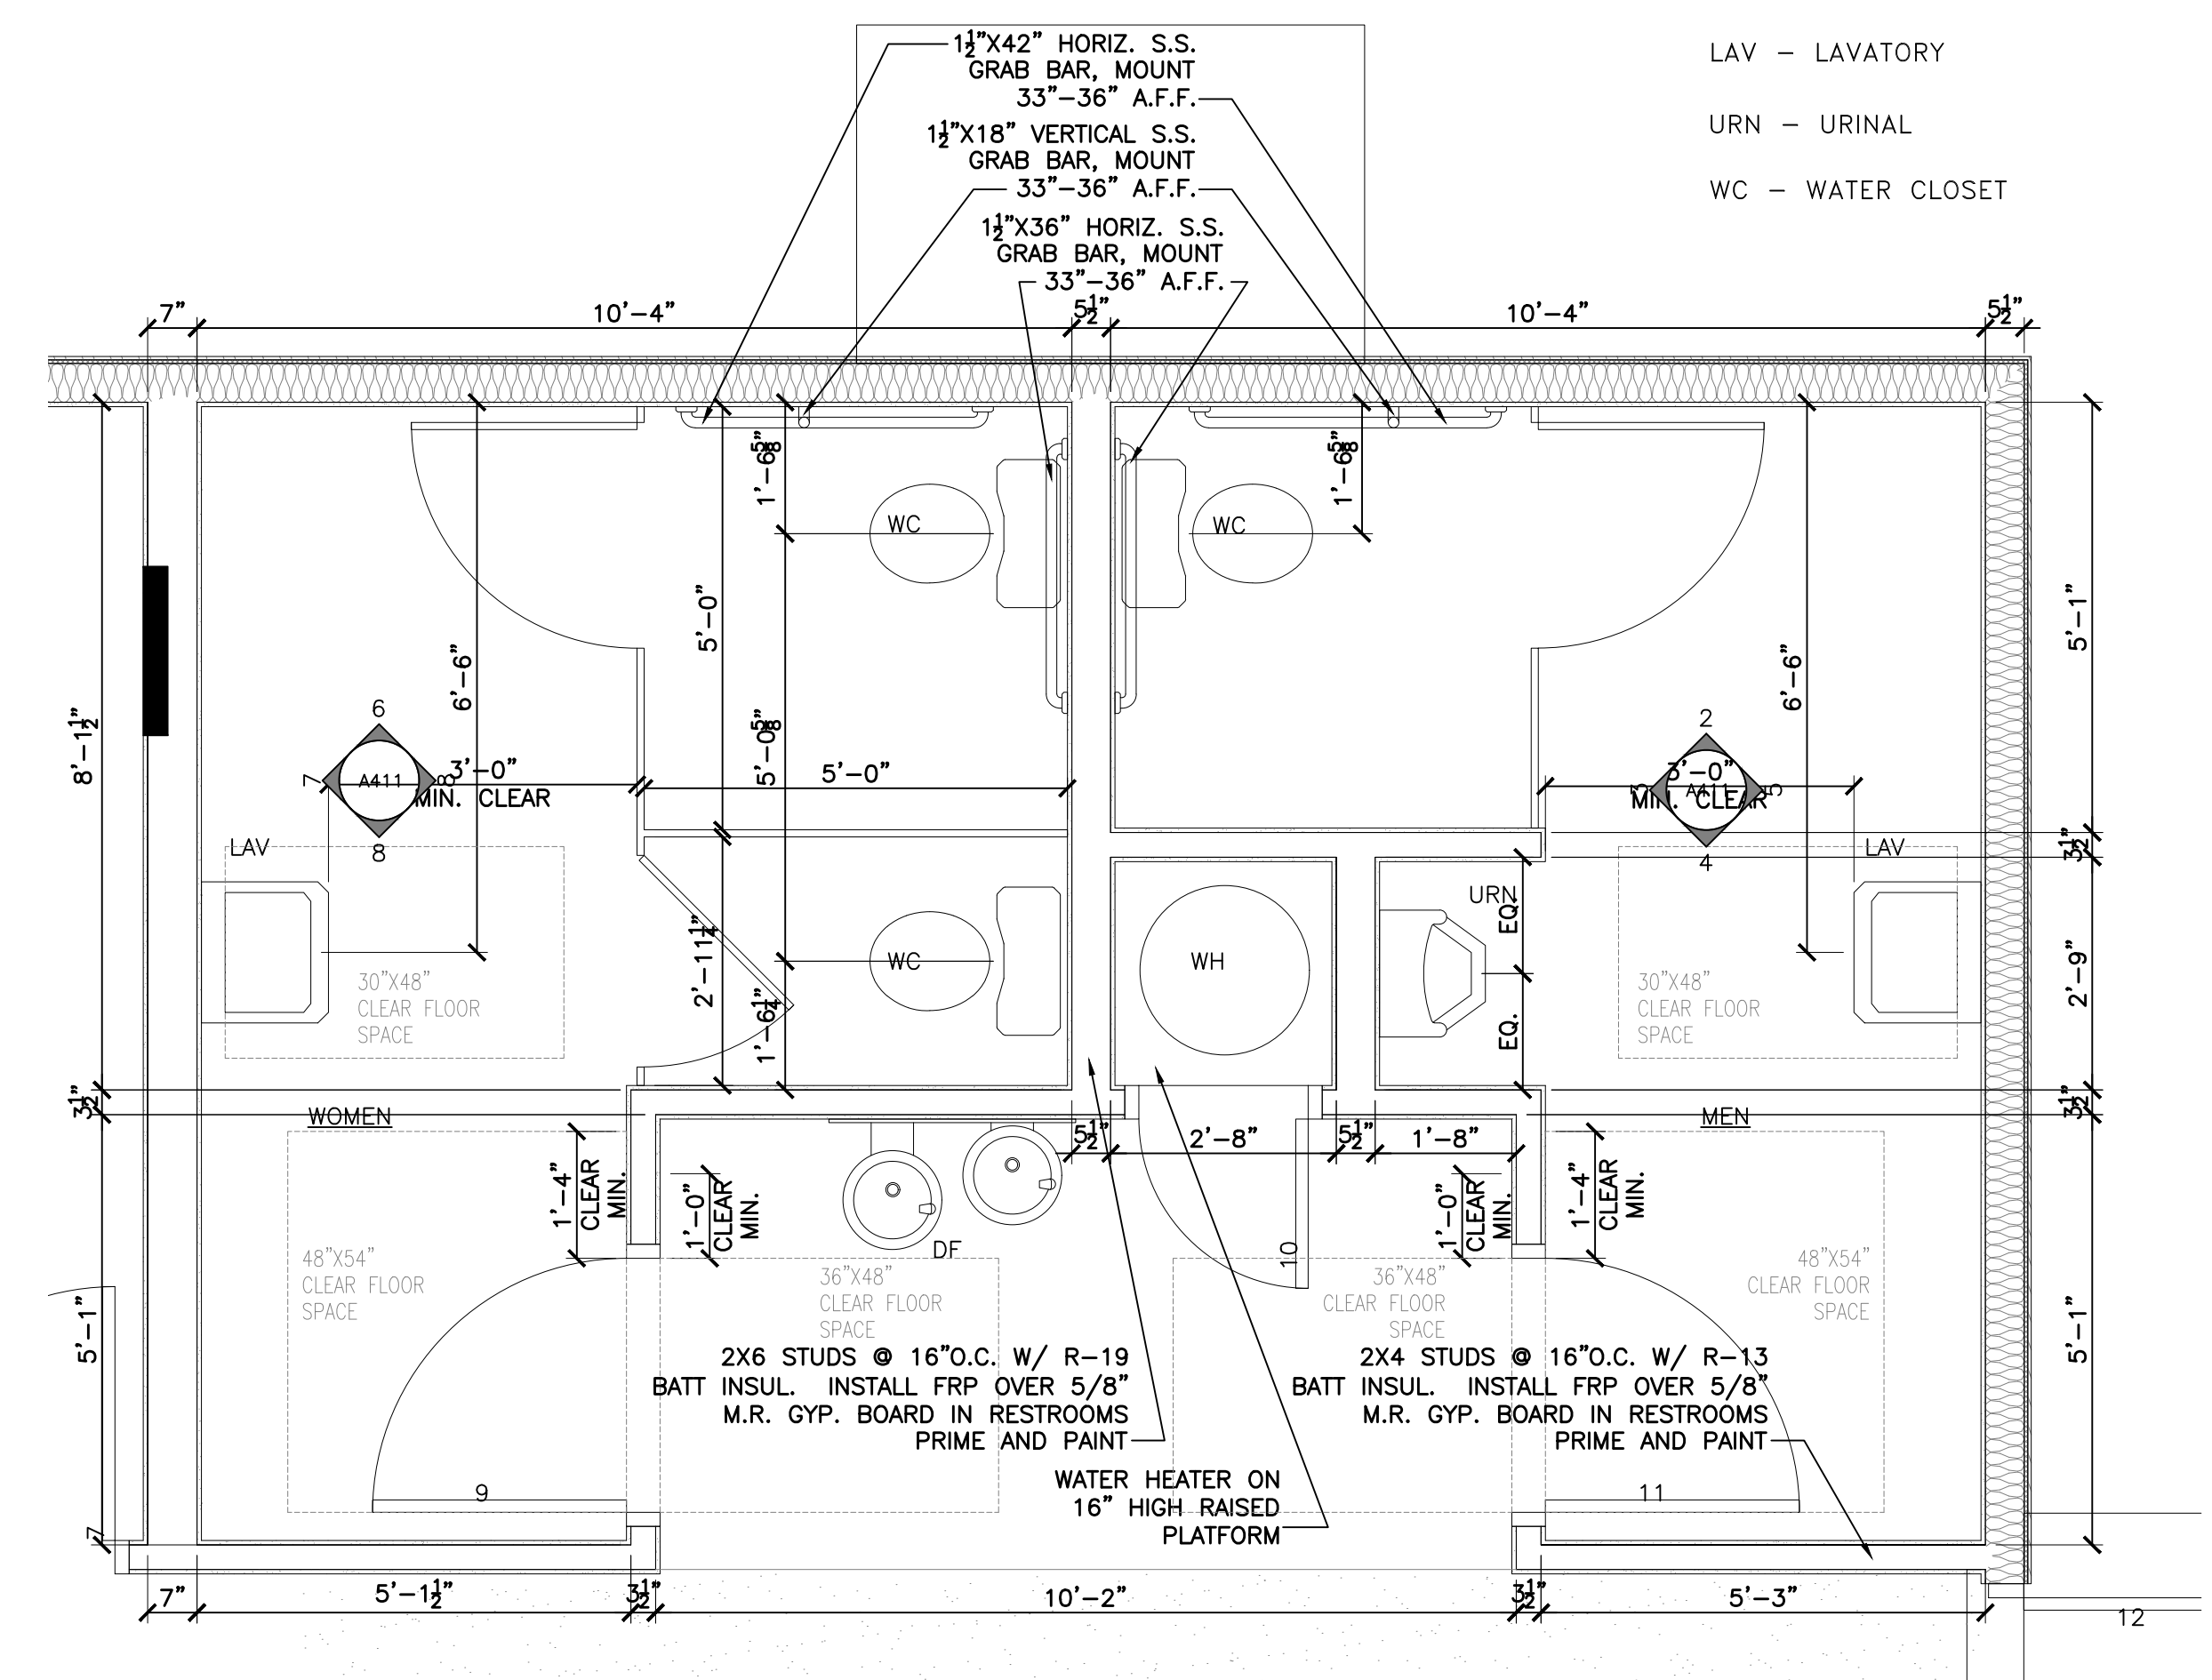
PLUMBING LEGEND

- DF - DRINKING FOUNTAIN
- HS - HAND SINK
- LAV - LAVATORY
- URN - URINAL
- WC - WATER CLOSET



NOTE: SEE SHEETS G121-G123 FOR ADDITIONAL ACCESSIBILITY INFORMATION
NOTE: HAND DRYERS, TOWEL DISPENSERS, VENDING MACHINES, ETC. SHALL BE MOUNTED SO THAT ITS OPERATING DEVICE, COINSLIT, ETC. IS NO MORE THAN 48" A.F.F.

5 RESTROOM ELEVATIONS
SCALE: 1/4" = 1'-0"



ENLARGED PLAN
2A
1/2" = 1' 2' 3'
1:24

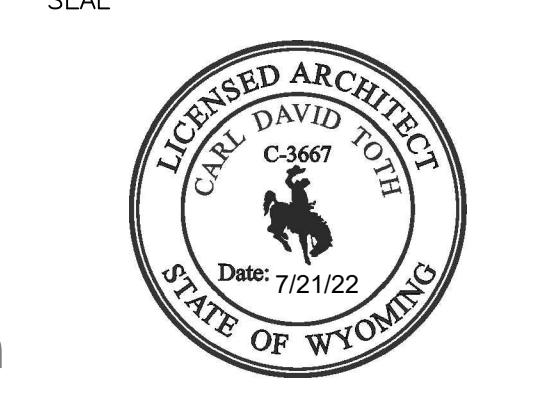
D O O R S C H E D U L E															
DOOR NUMBER		DOORS				FRAMES				FIRE RATING		HARDWARE		REMARKS	
		SIZE	ELEVATION	MATERIAL	GLASS	MATERIAL	ELEVATION	DETAILS			LABEL	CONST.	SET NO.		KEY SIDE ROOM NO.
								JAMB	HEAD	SILL					
1	SANCTUARY	3'-0" X 6'-8"	A	GA.HM.		GA.HM.	A				A	INSUL.	01		
2	OFFICE	3'-0" X 6'-8"	A	WD		HM	A				A	SC	02		
3	DRESSING ROOM	3'-0" X 6'-8"	A	WD		HM	A				A	SC	02		
4	DRESSING ROOM	3'-0" X 6'-8"	A	WD		HM	A				A	SC	02		
5	SANCTUARY	3'-0" X 6'-8"	A	GA.HM.		GA.HM.	A				A	INSUL.	01		
6	HALL	(2) 3'-0" X 6'-8"	A	WD		HM	B				A	SC	07		
7	CLASS ROOM	3'-0" X 6'-8"	A	WD		HM	A				A	SC	03		
8	CLASS ROOM	3'-0" X 6'-8"	A	WD		HM	A				A	SC	03		
9	WOMEN'S	3'-0" X 6'-8"	A	WD		HM	A				A	SC	04		
10	MECH.	2'-0" X 6'-8"	A	WD		HM	A				A	SC	02		
11	MEN'S	3'-0" X 6'-8"	A	WD		HM	A				A	SC	04		
12	EXTERIOR	(2)3'-0" X 6'-8"	B	AL	TEMP.	ALUM.	B				A		06		TEMP. GLASS
13	EXTERIOR	(2)3'-0" X 6'-8"	B	AL	TEMP.	ALUM.	B				A		06		TEMP. GLASS

HARDWARE SCHEDULE										
BUTTS	HARDWARE SET NO.	01	02	03	04	05	06	07	08	09
		1 1/2 PAIR		•	•	•	•	•		
3 PAIR							•	•		
LOCKSET	PUSH / PULL				•	•		•		
	CLASSROOM SET			•						
	EMER EXIT SET/PANIC DEVICE	•					•			
	OFFICE SET		•							
OTHER HARDWARE	CLOSER	•			•	•	•	•		
	SILENCER	•	•	•			•			
	WALL STOP				•	•		•		
	MASTER KEY CYLINDER	•	•	•			•			
	ASTRAGAL					•		•		

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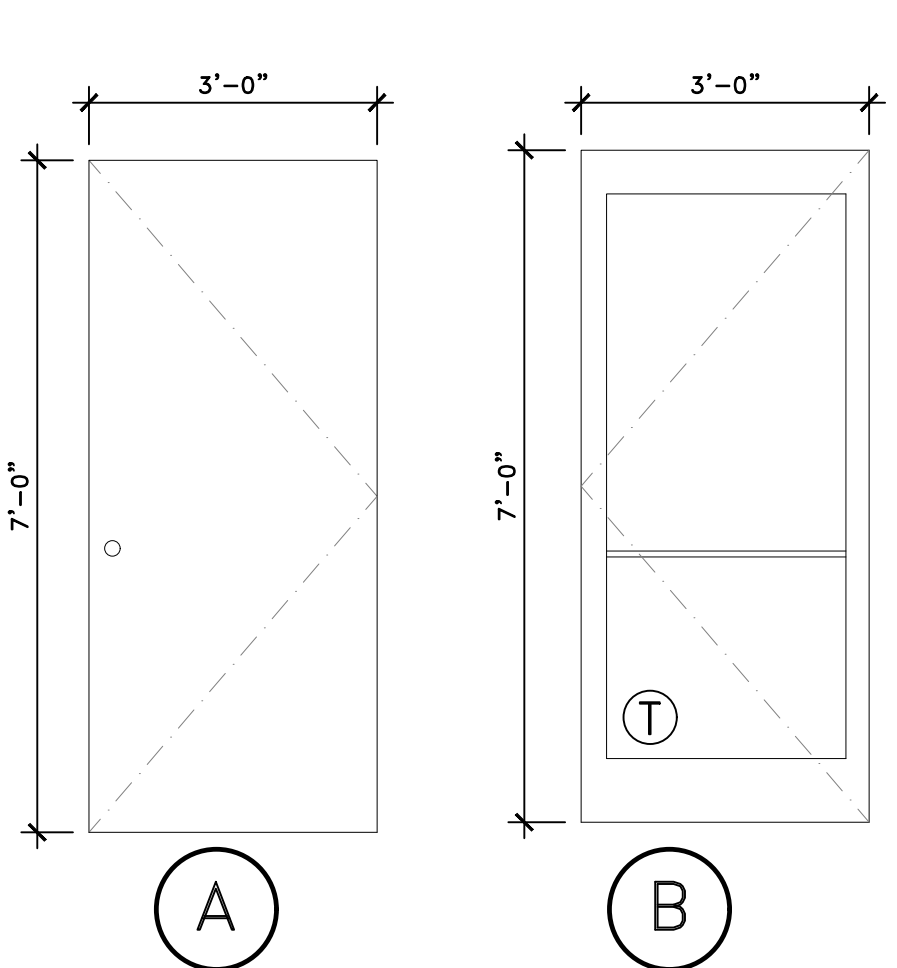
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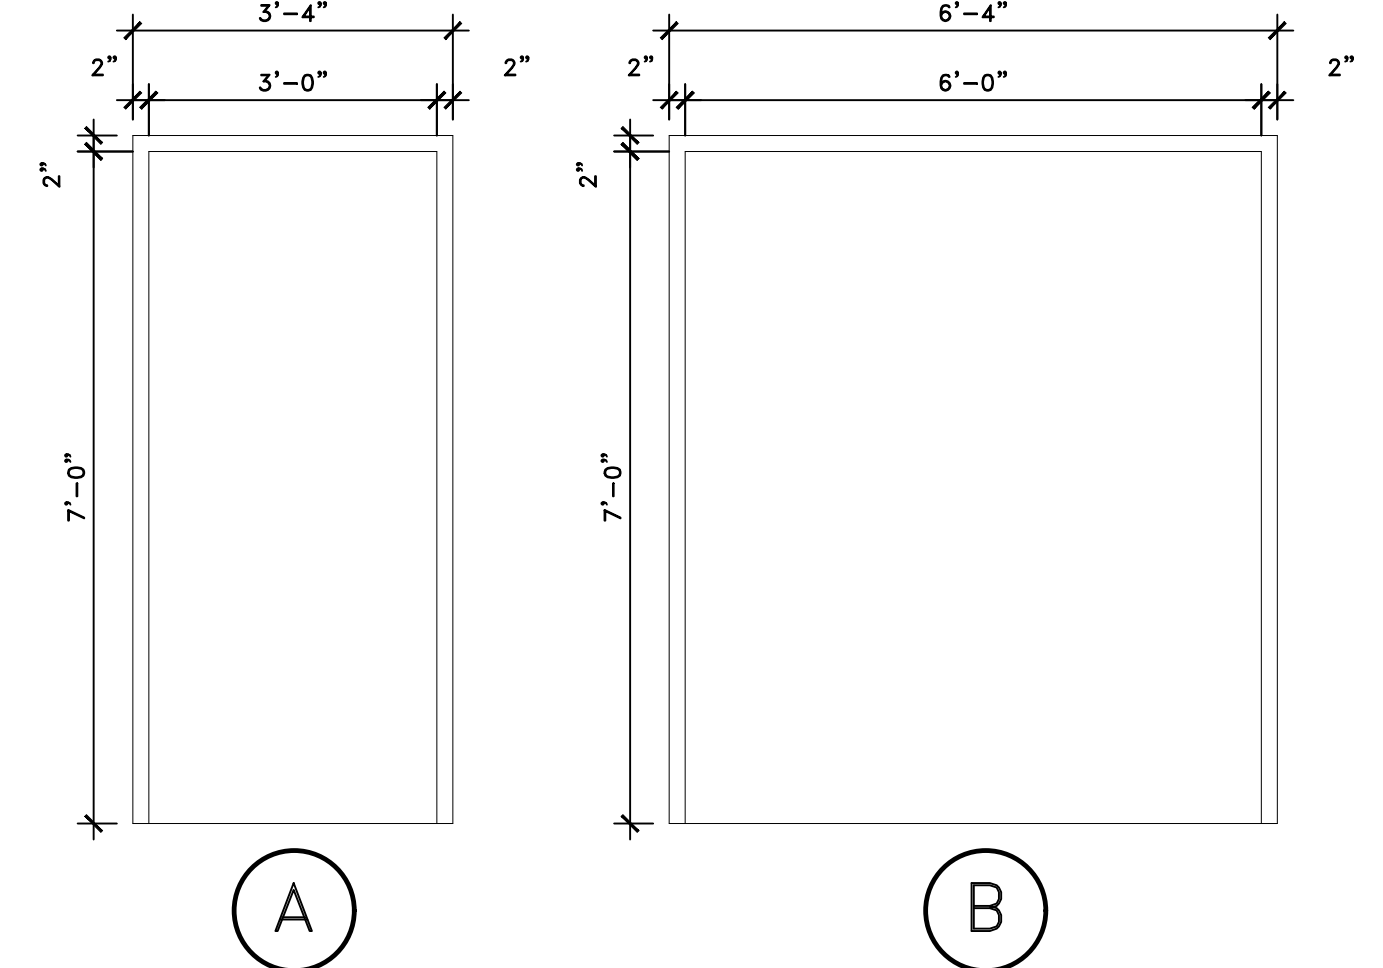
DATE: 07/21/2022
 PROJECT NO.: 22075
 CAD PLATFORM: ACA 2023
 PLOT REF. NO.: SEE LOWER LEFT
 DRAWING SCALE: SEE DRAWING

REVISIONS

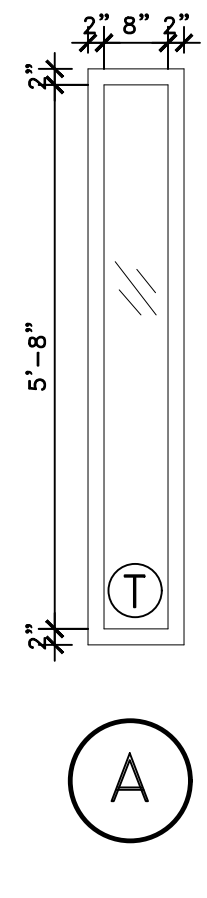
MARK	DATE	INIT.	DESCRIPTION



DOOR ELEVATIONS
 SCALE: 1/2" = 1'-0"



DOOR FRAMES
 SCALE: 1/2" = 1'-0"



WINDOW ELEVATIONS
 SCALE: 1/2" = 1'-0"

Ⓣ 1" INSULATED GLAZING

PROJECT TITLE

CIAD - WYOMING
 5 NEX PERCE DRIVE
 CODY, WYOMING 82414

SHEET TITLE
 ARCH - SCHD -
 DOOR AND FINISH

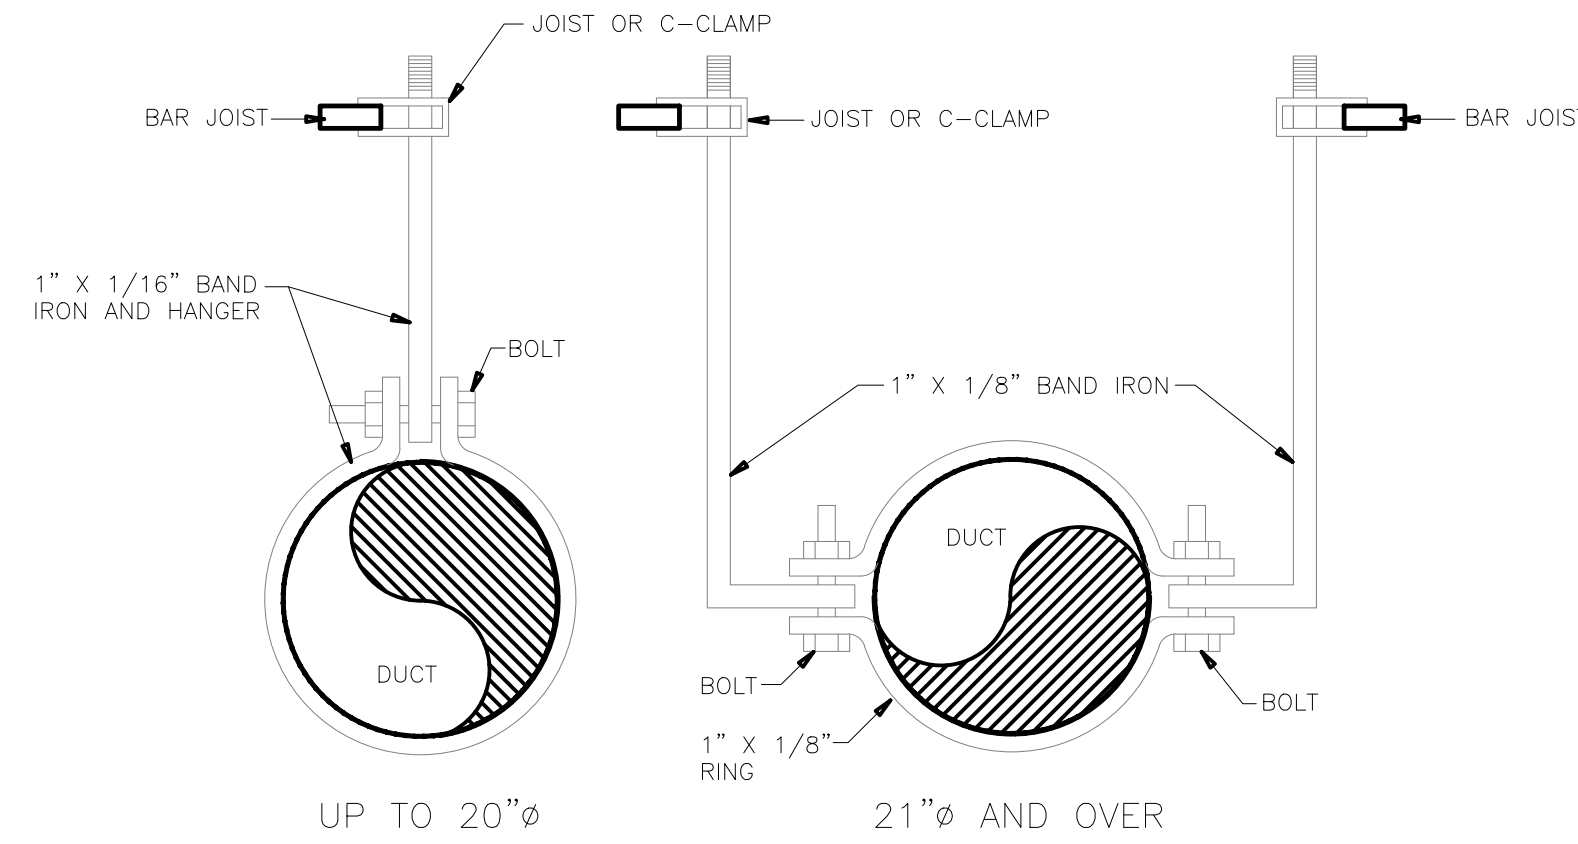
SHEET NUMBER

A611

SHEET: OF:

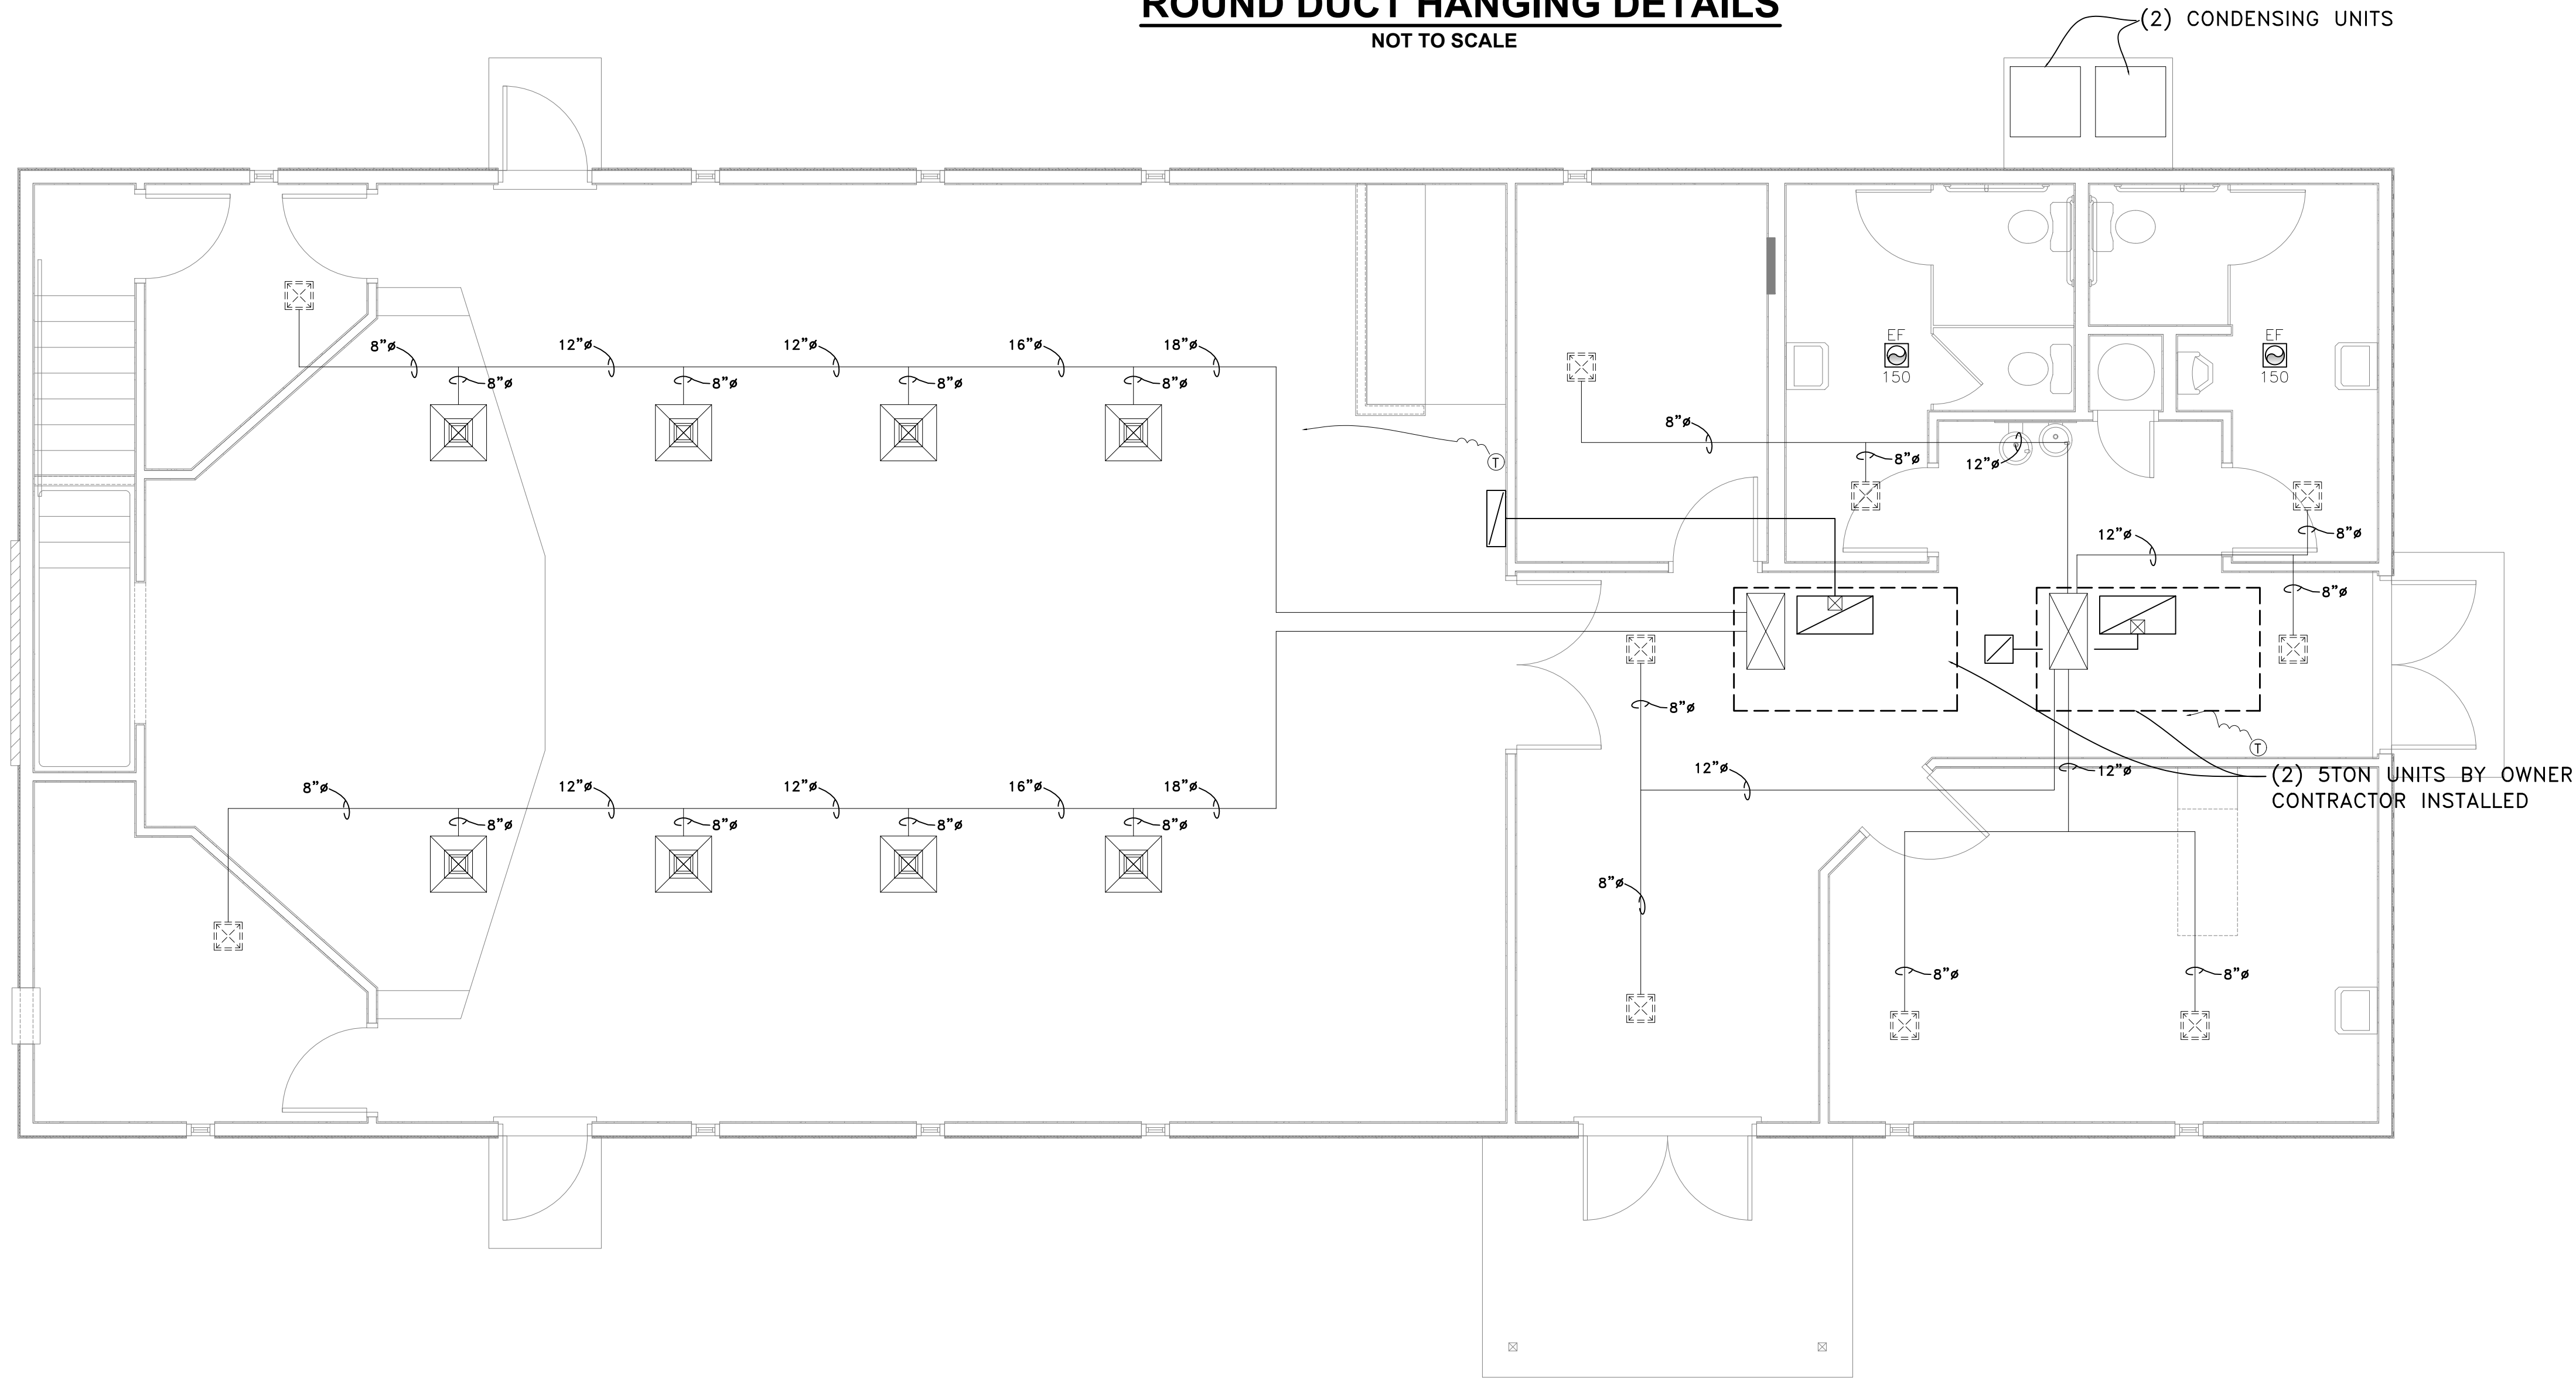
NOTE:

1. ALL DIFFUSERS SHALL BE FITTED w/ VOLUME DAMPERS.
2. SMOKE DETECTOR SHALL BE WIRED IN SERIES w/ START CIRCUIT FOR AIR HANDLING SYSTEMS.
3. A/V ALARMS SHALL BE MOUNTED IN A CONSPICUOUS LOCATION TO SIGNAL SHUTDOWN OF AIR SYSTEMS RESULTING FROM SMOKE DETECTION.
4. ALL DUCT DIMENSIONS ARE NOMINAL (TO INSIDE OF INSUL.)
5. DO NOT WRAP ROUND DUCT.
6. SMOKE DETECTORS SHALL BE WIRED TO SHUT DOWN ALL AIR SYSTEMS IN BUILDING.
7. SPIRAL DUCT SHALL BE FREE OF EXPOSED CAULK, SCREWS CONNECTIONS, ETC.



NOTES:
 1. SEE DUCTS SHALL BE SUPPORTED IN ACCORDANCE WITH SMACNA HVAC DUCT CONSTRUCTION STANDARDS FOR METAL AND FLEXIBLE AS PER IMC SEC. 603.10. PLACEMENT TO NOT EXCEED 12'-0" INTERVALS.

ROUND DUCT HANGING DETAILS
 NOT TO SCALE



FIRST FLOOR
 MECHANICAL
PLAN
 2A
 1/4" = 1' 4' 6'
 1:48

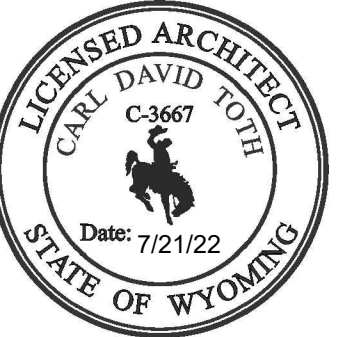
HVAC SYMBOL LEGEND	
MARK	DESCRIPTION
RTU	ROOF TOP UNIT (RTU)
WxH	SUPPLY-AIR DUCT, RECTANGULAR OR ROUND (SEE PLAN), GALVANIZED METAL (ASHRAE AND SMACNA STANDARDS). SEAL ALL JOINTS WITH WATER-BASED, NOT-TOXIC SEALER. HOLD ALL DUCTWORK TIGHT TO JOISTS.
WxH	SUPPLY-AIR DUCT, FLEXIBLE, U.L. CLASS 1. FULL INTERNAL REINFORCEMENT OF TRILAMINATE OR POLYESTER BONDED CORROSIVE RESISTANT STEEL HELIX, 1/2" R-5.79 FIBERGLASS INSULATION WITH VAPOR BARRIER
WxH	RETURN-AIR DUCT, GALVANIZED METAL
WxH	VOLUME CONTROL DAMPER
CFM SIZE	SUPPLY-AIR DIFFUSER, TITUS MODEL TDCA SQUARE WITH ADJUSTABLE FACE, WITH MODEL EGS EQUALIZING GRID, AND WITH MODEL AG-95 VOLUME DAMPER OR EQUAL
CFM SIZE	RETURN-AIR GRILLE, DUCTED
CFM SIZE	RETURN-AIR GRILLE, TITUS MODEL 350 FL OR FS, 3/4" BLADE SPACING, 35° BLADE ANGLE, #3 LAY-IN BORDER, 24"x24", OR EQUAL
EF CFM	EXHAUST FAN, GREENHECK MODEL SP-D150, 150 CFM AT 0.25" S.P., 129 WATT, 115V, 1PH.
Ⓢ	THERMOSTAT, HONEYWELL T7300, SEVEN DAY PROGRAMMABLE OR EQUAL OR AS PROVIDED BY LESSOR
⊗	SMOKE DETECTOR - IN RETURN AIR DUCT

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DATE: 07/21/2022
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REVISIONS	
MARK	DATE / INIT. / DESCRIPTION

PROJECT TITLE

CIAD - WYOMING
 5 NEX PERCE DRIVE
 CODY, WYOMING 82414

SHEET TITLE
 MECH - PLAN -
 FLR - 01

SHEET NUMBER

M111

SHEET: OF:

PLUMBING LINE LEGEND



PLUMBING LEGEND

- HS - HAND SINK
- LAV - LAVATORY
- WC - WATER CLOSET (1" SUPPLY)
- DF - DRINK FOUNTAIN
- FD - FLOOR DRAIN
- URN - URINAL

PIPING LEGEND



PLUMBING NOTES

- PLUMBING INSTALLATIONS SHALL MEET ALL FEDERAL, STATE & LOCAL CODES COVERING SUCH INSTALLATIONS.
- ALL WATER SERVICES SHALL BE RUN IN TYPE "L" HARD DRAWN COPPER USING 95/5 SOLDER.
- ALL LINES SHALL BE SQUARE AND PLUMB WITH THE BUILDING AND LINES SHALL BE CONCEALED WHERE POSSIBLE.
- INSULATE ALL HOT AND COLD WATER LINES. w/ 1/2" AEROTUBE (ARMAFLEX)
- PROVIDE DIELECTRIC CONNECTIONS AT ALL LOCATIONS WITH FERROUS MATERIALS.
- PROVIDE TEMPERING VALVE AT WATER HEATER TO LIMIT WATER TEMPERATURE TO 110 DEGREES.
- PROVIDE LINE SIZE SHUT-OFF VALVES AT ALL EQUIPMENT LOCATIONS.
- WATER HEATER SHALL BE RHEEM (OR EQUAL) 30 GAL. ELECTRIC.
- PROVIDE THERMAL EXPANSION TANK AT WATER HTR.

SANITARY SEWER NOTES

- ALL SEWER LINES SHALL BE PITCHED A MINIMUM OF 1% PER FOOT IN DIRECTION OF FLOW.
- FLOOR DRAINS TO BE SET FLUSH WITH FINISHED FLOOR. USE SQUARE CHROME PLATED STRAINER.
- INSULATE DRAINS OF HANDICAPPED ACCESSIBLE LAVS. WITH FOAMED RUBBER BOOT OR CONFIGURE AS REQUIRED PER ADA AND STATE ACCESSIBILITY CODE AND ALL OSHA REQUIREMENTS. DO NOT USE FIBERGLASS INSULATION.
- ALL FOUNDATION PENETRATIONS SHALL BE 4" MIN. & EMPLOY CAST IRON SLEEVES

MARK	DESCRIPTION	REMARKS
L-1	LAVATORY: ADA ACCESSIBLE, ADA FAUCET, PIPE WRAP, BY TENANT	1
WC-1	WATER CLOSET: A.D.A. ACCESSIBLE HEIGHT, BY TENANT	1,2
WH-1	WATER HEATER: BY TENANT, MUST HAVE TEMPERATURE CONTROL ON THE UNIT OR A SEPARATE MIXING VALVE IS REQUIRED TO PREVENT SCALDING	
W-1	WASHER BY TENANT, GC TO PROVIDE OATEY WASHER BOX WITH HAMMER ARRESTOR ON BOTH HOT AND COLD WATER.	
SH-1	3'X3' TRANSFER SHOWER, ADA AND ANSI COMPLIANT, PROVIDE COMPLETE WITH BLOCKING AND GRAB BARS, HAND HELD SHOWER, SEAT, AND SHOWER CURTAIN	1
SINK-1	HAIR WASHING SINK - BY TENANT	
FD-1	FLOOR DRAIN: ZURN MODEL 415B, PROVIDE TRAP PRIMER OR TRAP GUARD IF PERMITTED BY LOCAL JURISDICTION	

1. ALL PLUMBING FIXTURES MUST MEET ALL REQUIREMENTS FOR ADA/ANSI COMPLIANCE. SEE SHEETS 6121-6123 FOR REFERENCE.
 2. ALWAYS MOUNT TRIP LEVER ON OPEN, WIDE SIDE OF TOILET (SIDE OPPOSITE NEAREST SIDE WALL). WHERE FLUSH CONTROL NEEDS TO BE ON RIGHT HAND SIDE, PROVIDE RIGHT HAND TRIP LEVER.

GENERAL NOTES:

- COMPLY WITH INDIANA PLUMBING CODE (I.P.C.) AND ALL APPLICABLE FEDERAL, STATE, MUNICIPAL, AND LOCAL CODES, ORDINANCES, STANDARDS, AND REGULATIONS.
- PROVIDE EVERY ITEM ASSOCIATED WITH THE PLUMBING SYSTEM. PROVIDE TOILETS AND SEATS, WATER HEATERS, FAUCETS, AND DRAINS. SUBMIT LITERATURE FOR ALL ITEMS TO THE ARCHITECT FOR APPROVAL BEFORE PURCHASING.
- PROVIDE LABOR AND MATERIAL TO CONNECT ALL FIXTURES TO WATER SUPPLY AND ALL DRAINS TO THE CITY SEWER.
- COORDINATE ALL UNDER-SLAB WORK WITH OTHER AFFECTED TRADES BEFORE INSTALLATION.
- DO NOT INSTALL PIPING DIRECTLY OVER ELECTRICAL POWER DISTRIBUTION CABINETS. CONFIRM PANEL LOCATIONS PRIOR TO PIPING INSTALLATION.
- PROVIDE CHROME PLATED PIPE FOR ALL EXPOSED PIPING.
- INSULATE EXPOSED SUPPLY AND DRAIN LINES AT ACCESSIBLE FIXTURES WHERE NO BASE CABINET OCCURS BENEATH A LAVATORY OR SINK.
- PROPERLY CAULK ALL PLUMBING PENETRATIONS AND GAPS THROUGH WALLS AND SLAB. PROVIDE FIRE STOP SEALANT AT ANY RATED WALLS.

DOMESTIC WATER:

- SUBMIT DOMESTIC WATER SUPPLY PIPING DIAGRAM PRIOR TO INSTALLATION OF ANY PIPE.
- PROVIDE 1" WATER LINE.
- PROVIDE AN ACCESSIBLE MASTER SHUT-OFF VALVE LOCATED BY THE WATER HEATER OR WATER SOFTENER.
- FOR DOMESTIC WATER PIPING ABOVE GRADE OR WITHIN BOUNDARIES OF FOUNDATION BELOW GRADE, USE COPPER, PVC (COLD), CPVC (HOT), OR PEX (POLYETHYLENE CROSS-LINKED) TUBING AND FITTINGS.
- PROVIDE INDIVIDUAL WATER SUPPLY SHUT-OFF VALVES FOR ALL PLUMBING FIXTURES.
- ADJUST SUPPLY LINE WALL PENETRATION HEIGHTS AS NEEDED TO AVOID CONFLICTS BETWEEN FLUSH VALVES AND GRAB BAR MOUNTING HEIGHTS. GRAB BAR HEIGHTS TAKE PRIORITY.
- PROVIDE AIR CHAMBER, FULL PIPE SIZE, AT EACH HOT AND COLD WATER CONNECTION, 18" LONG.
- PRESSURE TEST ALL WATER LINES BEFORE INSTALLING GYPSUM BOARD.

WASTE PIPING:

- FOR ALL SANITARY WASTE PIPING, USE SCHEDULE 40 PVC OR HUBLESS CAST IRON
- PROVIDE CODE APPROVED TRAPS FOR ALL PLUMBING FIXTURES.
- FOR SINGLE RUN-OUTS TO PLUMBING FIXTURES, USE SAME SIZE AS ON THE PLUMBING FIXTURE SCHEDULE UNLESS OTHERWISE NOTED.
- PROVIDE TRAPS WITH WATER SEALS FOR ALL FIXTURE DRAINS EXCEPT FIXTURES WHICH HAVE INTEGRAL TRAPS (WATER CLOSETS). DOUBLE-TRAPPING ANY FIXTURE IS PROHIBITED BY CODE.
- NOT USED
- SET FLOOR DRAINS PRIOR TO POURING FLOOR SLAB.

WASTE VENTING:

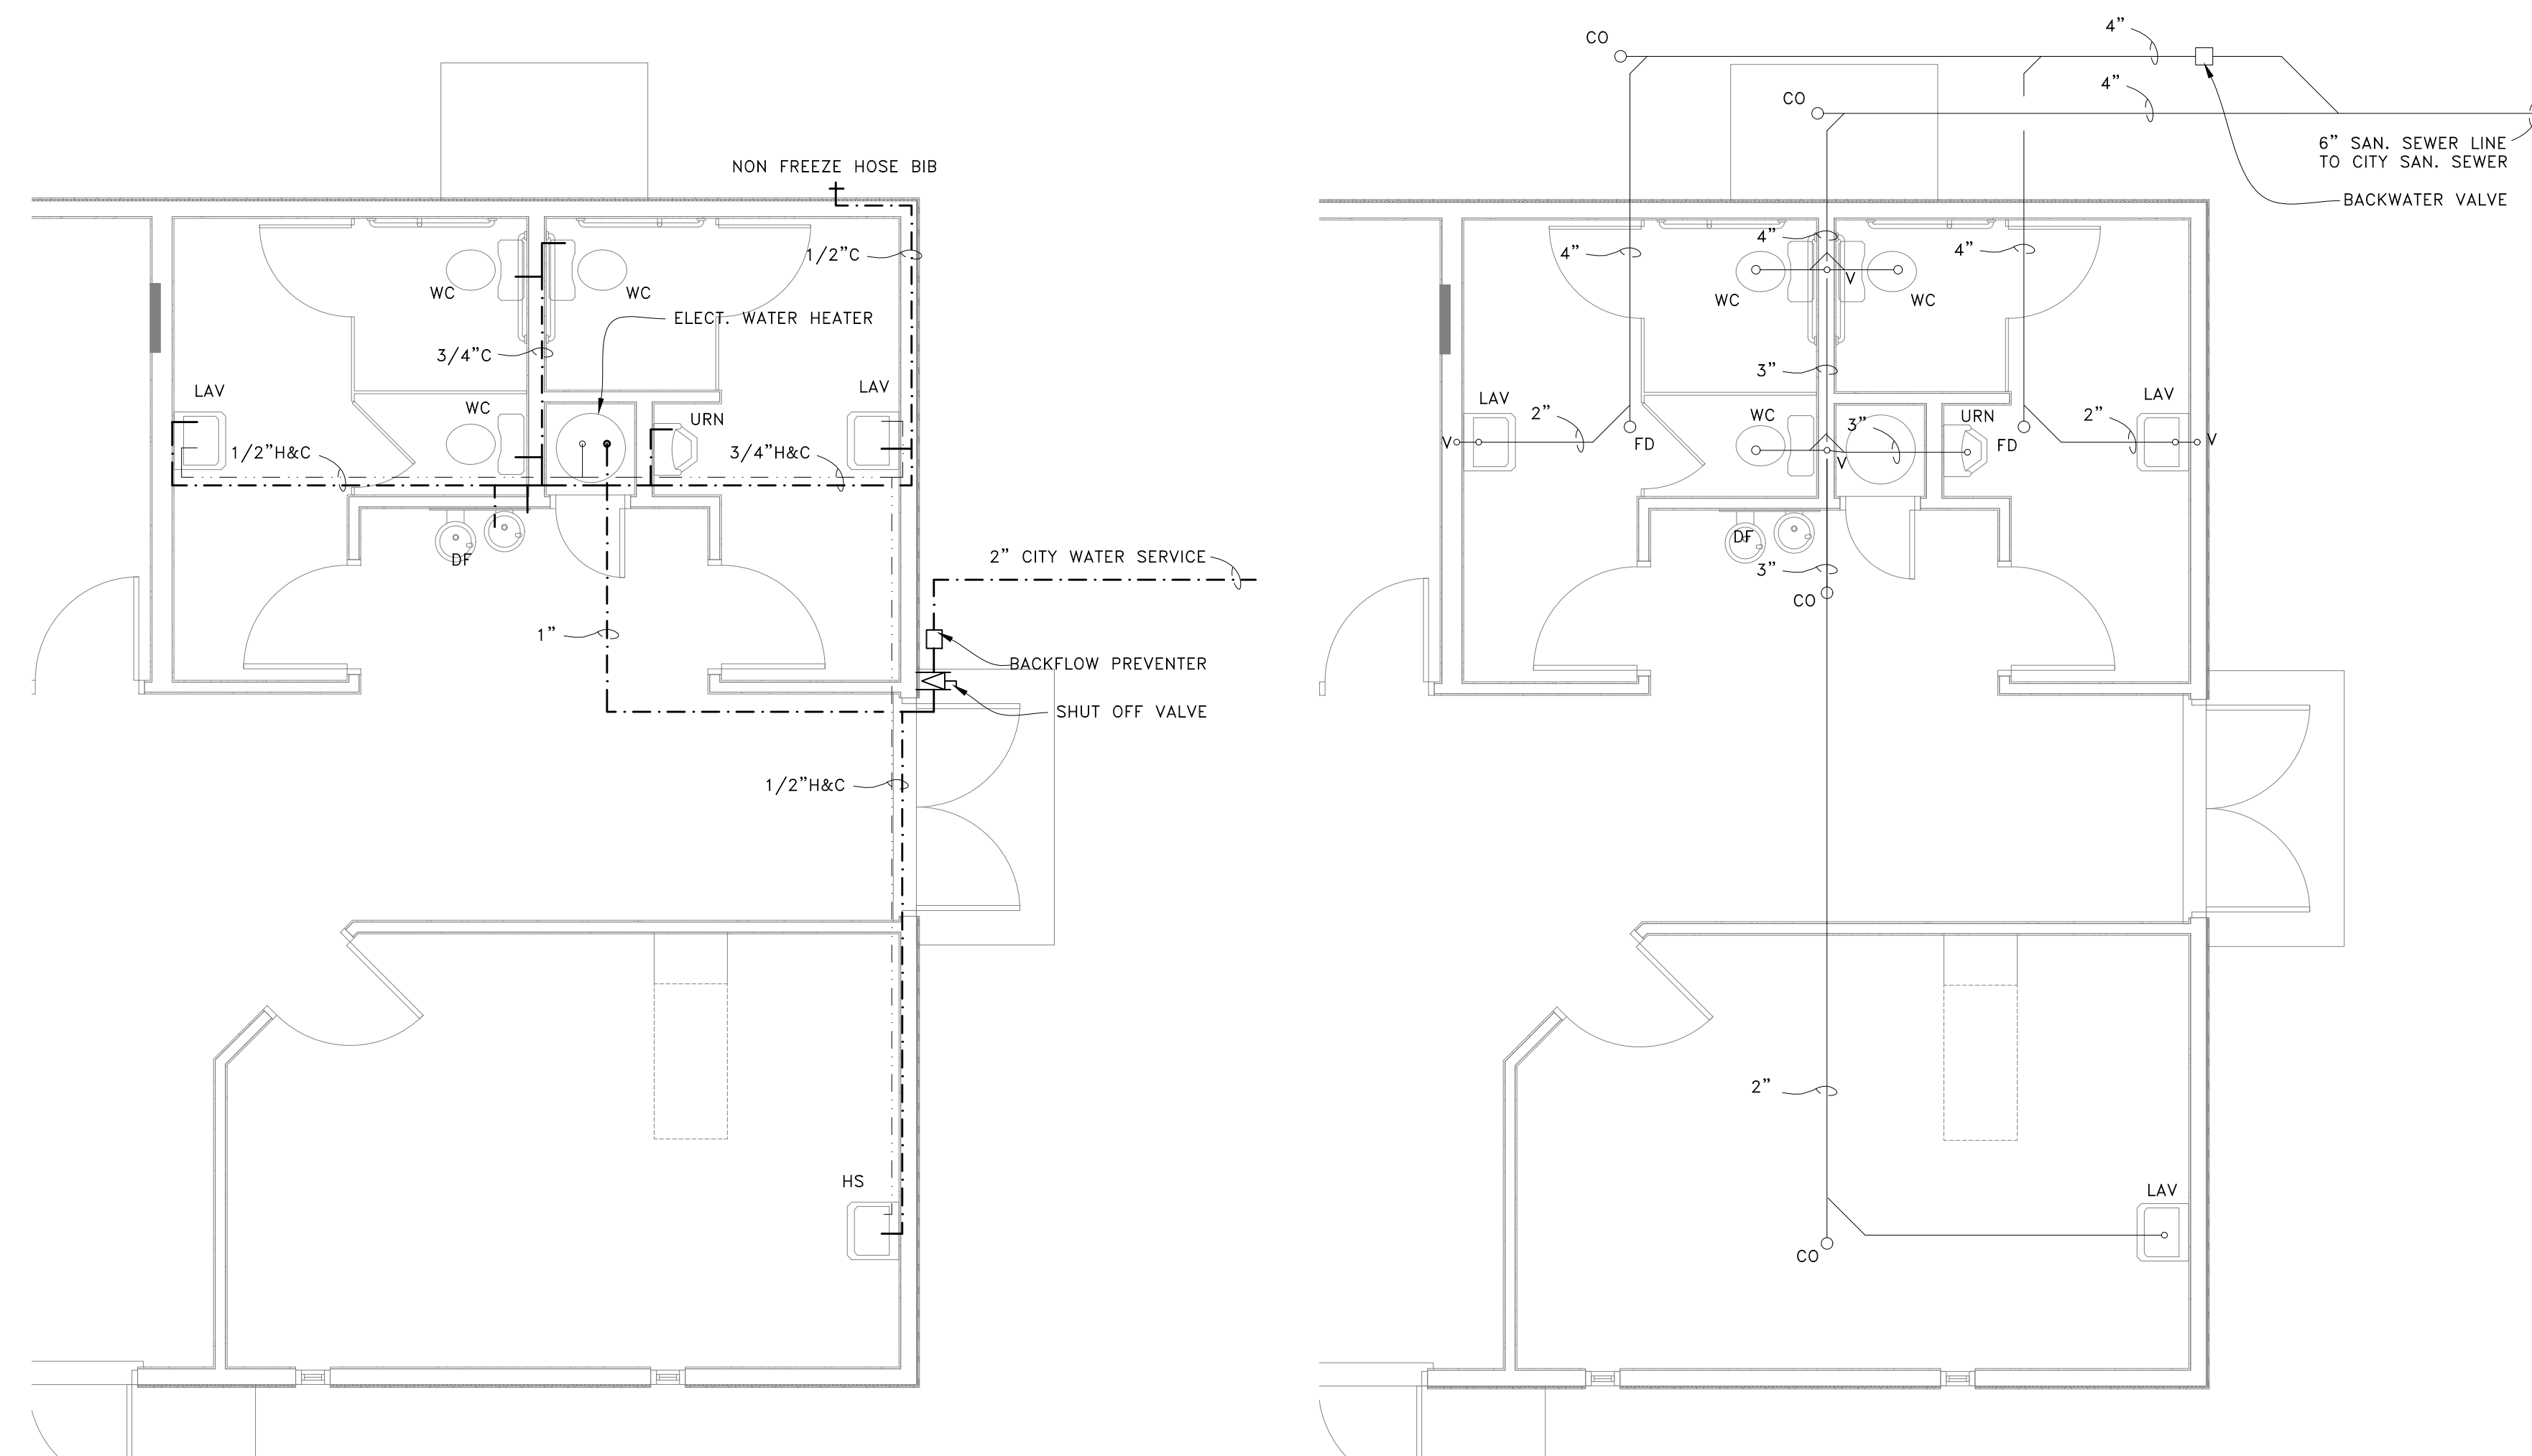
- FOR ALL SANITARY VENT PIPING, USE SCHEDULE 40 PVC OR HUBLESS CAST IRON.
- INDIVIDUALLY VENT ALL PLUMBING FIXTURES; GANG VENTING OF INDIVIDUAL UNIT VENTS INTO ONE COMMON VENT WILL NOT BE ACCEPTED.
- PLACE VENTS ON BACK SIDE OF ROOFS AND PAINT BLACK.

PLUMBING FIXTURES AND PLUMBED APPLIANCES:

- FOR ALL PLUMBING FIXTURES, INSTALL WITH APPROVED BACKFLOW PREVENTION DEVICES.
- DO NOT CAULK TOILET BASE.
- FOR ALL TOILETS, PROVIDE HANDLES ON OPEN SIDE (SIDE OPPOSITE WALL NEAREST SIDE OF TOILET) OF THE FIXTURE.
- USE LOW FLOW DEVICES FOR LAVATORY AND SINK FAUCETS.

SPECIFIC NOTES:

- PO1: CAP EXISTING SANITARY RISER BELOW FLOOR SLAB.
- PO2: CONNECT TO EXISTING SANITARY WITH ELBOW IN DIRECTION OF FLOW.
- PO3: EXISTING WATER LINE STUB. PROVIDE REDUCER CONNECTION JOINT AND REDUCER (IF REQUIRED).
- PO4: TEMPERATURE AND PRESSURE RELIEF VALVE.



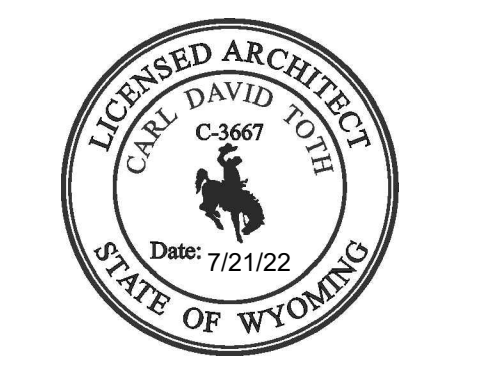
4A FIRST FLOOR PLUMBING PLAN
 1/4"=1' 4' 6'
 1:48

2A FIRST FLOOR WASTE PLAN
 1/4"=1' 4' 6'
 1:48



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DATE: 07/21/2022
 PROJECT NO.: 22075
 CAD PLATFORM: ACA 2023
 PLOT REF. NO.: SEE LOWER LEFT
 DRAWING SCALE: SEE DRAWING

MARK	DATE	INIT.	DESCRIPTION

PROJECT TITLE

CIAD - WYOMING
 5 NEX PERCE DRIVE
 CODY, WYOMING 82414

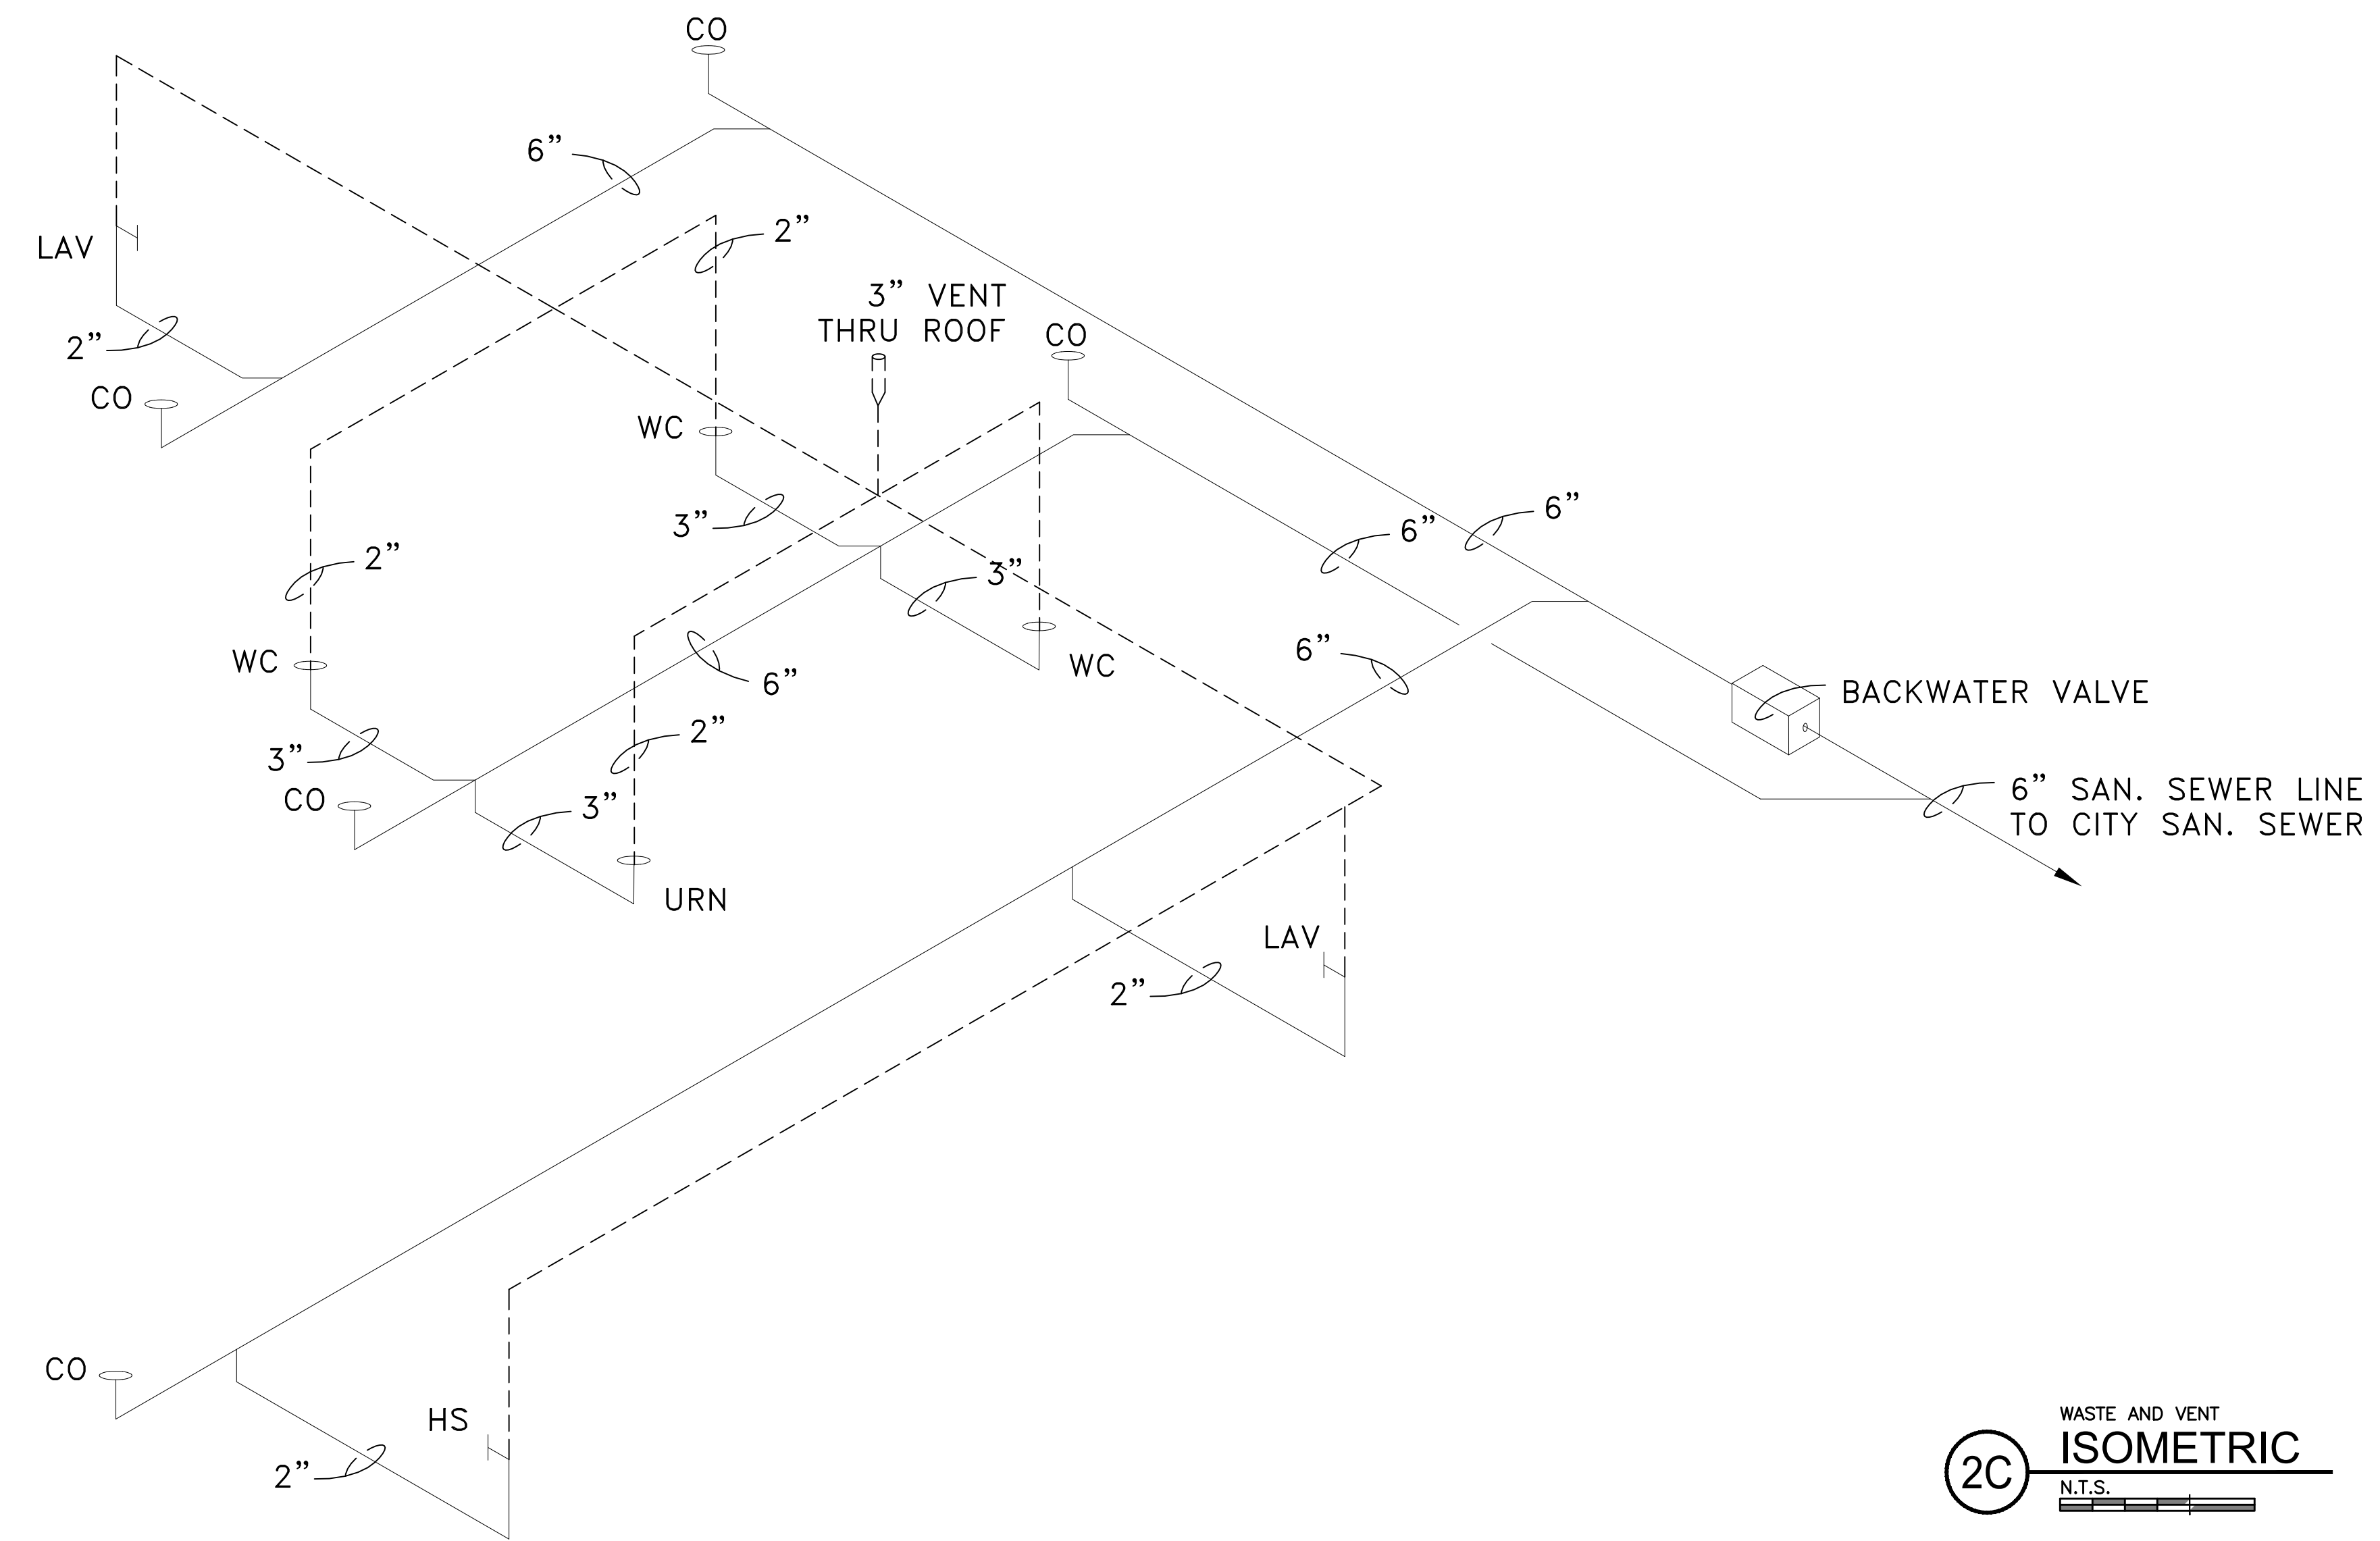
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 PLUMB - PLAN -
 FLR - 01

SHEET NUMBER

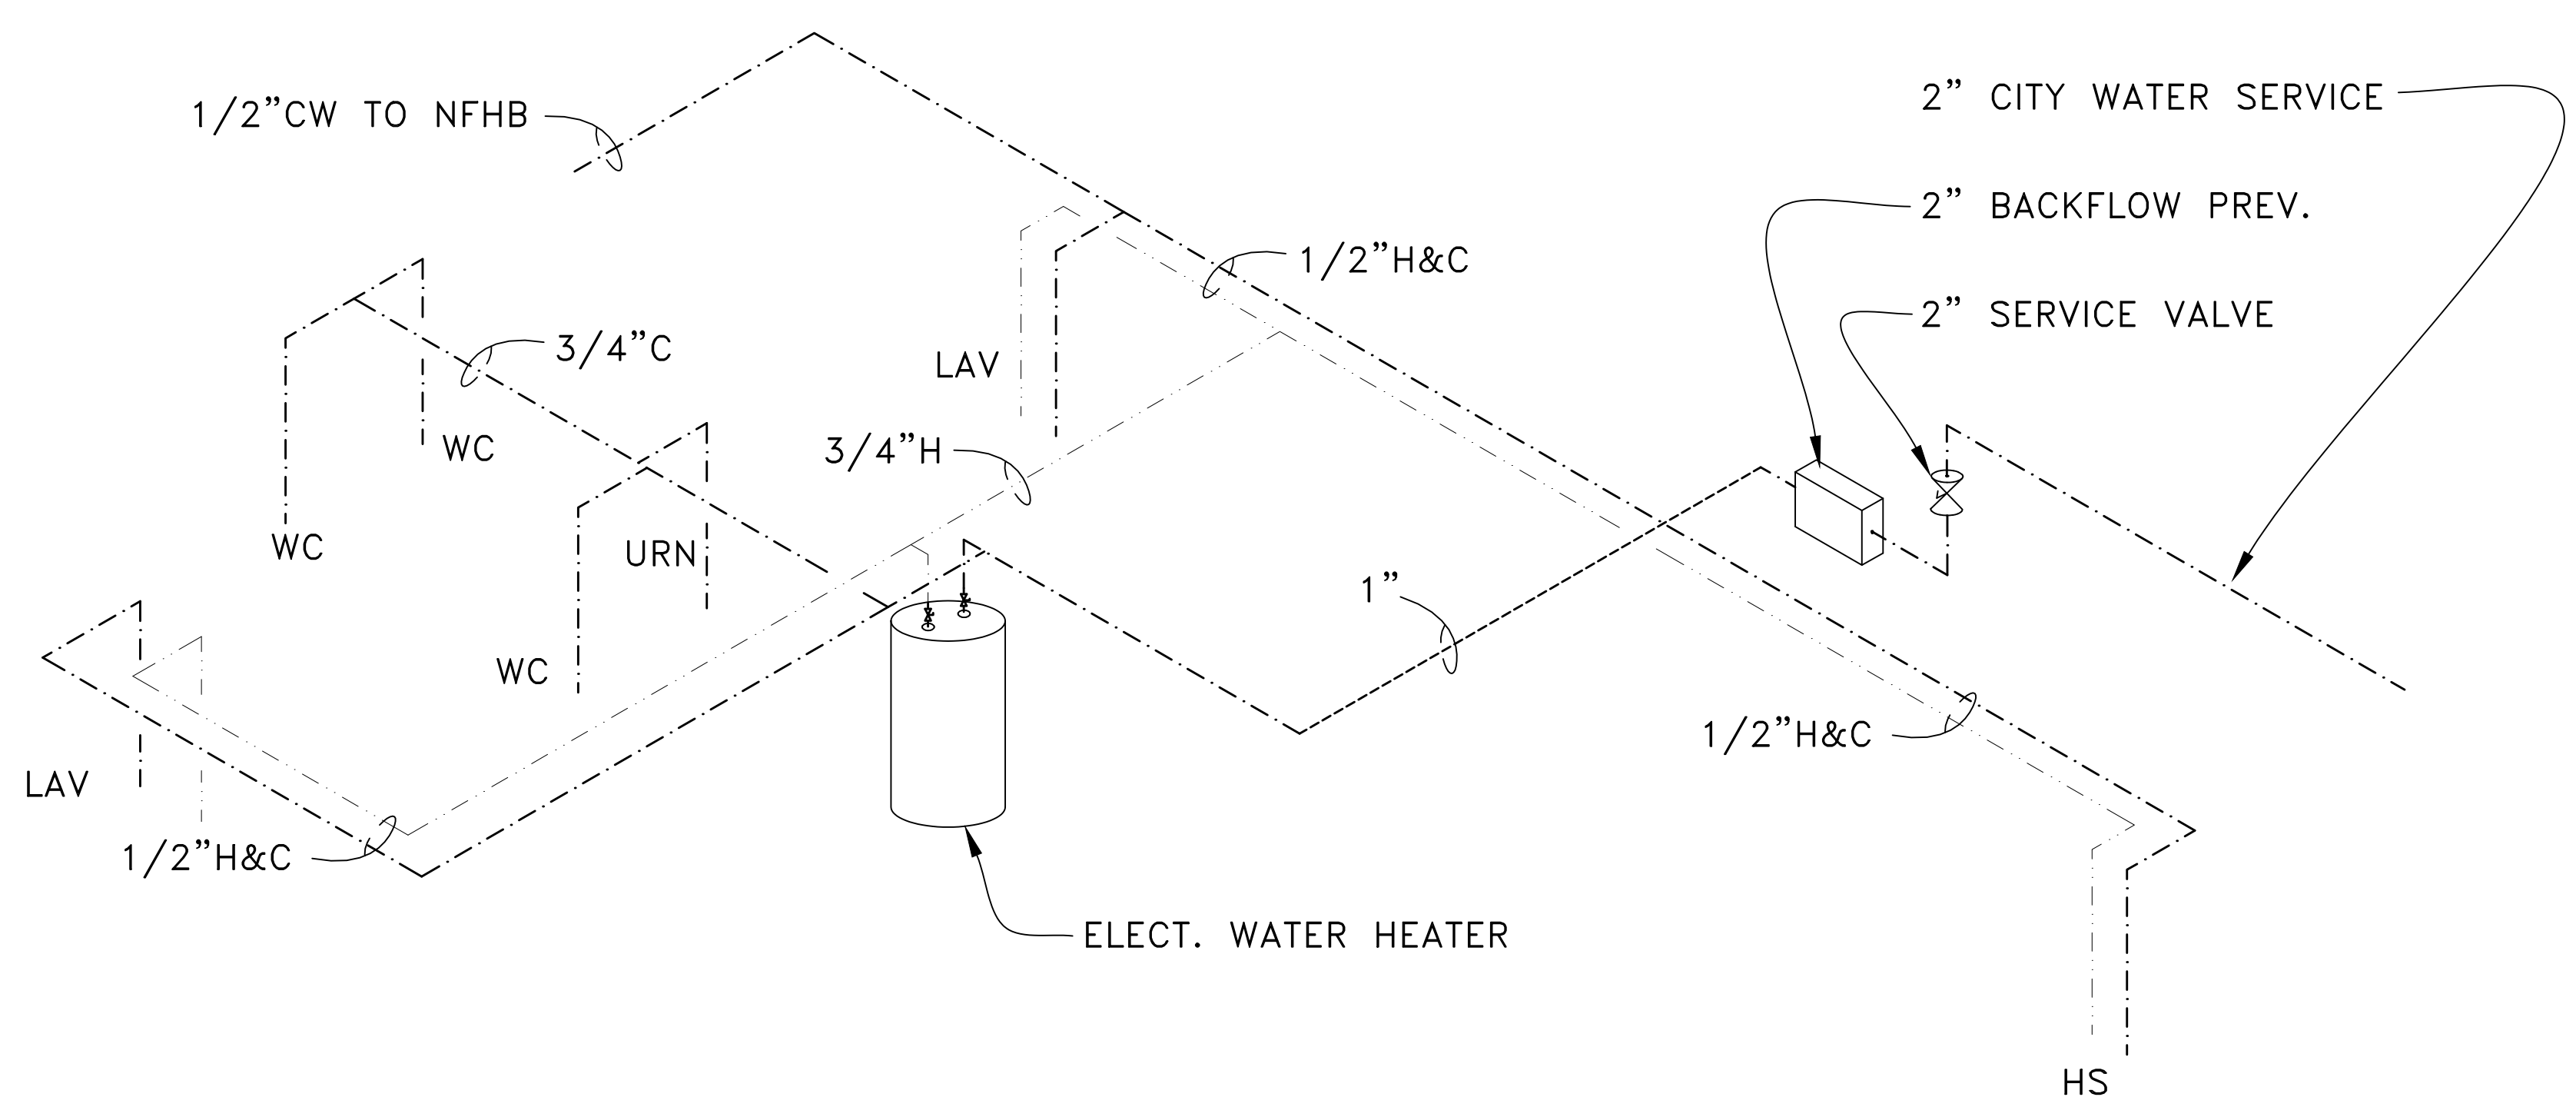
P111

SHEET: OF:

FILE: S:\BRANDON\VERY LONG\WYOMING CAD\CAD - WYOMING\SHEETS\22075-P111 PLUMB - PLAN - FLR - 01.DWG
 TIME: 2022/07/19 15:12



2C WASTE AND VENT ISOMETRIC N.T.S.



2A DOMESTIC WATER ISOMETRIC N.T.S.

GENERAL NOTES:

1. COMPLY WITH INDIANA PLUMBING CODE (I.P.C.) AND ALL APPLICABLE FEDERAL, STATE, MUNICIPAL, AND LOCAL CODES, ORDINANCES, STANDARDS, AND REGULATIONS.
2. PROVIDE EVERY ITEM ASSOCIATED WITH THE PLUMBING SYSTEM. PROVIDE TOILETS AND SEATS, WATER HEATERS, FAUCETS, AND DRAINS. SUBMIT LITERATURE FOR ALL ITEMS TO THE ARCHITECT FOR APPROVAL BEFORE PURCHASING.
3. PROVIDE LABOR AND MATERIAL TO CONNECT ALL FIXTURES TO WATER SUPPLY AND ALL DRAINS TO THE CITY SEWER.
4. COORDINATE ALL UNDER-SLAB WORK WITH OTHER AFFECTED TRADES BEFORE INSTALLATION.
5. DO NOT INSTALL PIPING DIRECTLY OVER ELECTRICAL POWER DISTRIBUTION CABINETS. CONFIRM PANEL LOCATIONS PRIOR TO PIPING INSTALLATION.
6. PROVIDE CHROME PLATED PIPE FOR ALL EXPOSED PIPING.
7. INSULATE EXPOSED SUPPLY AND DRAIN LINES AT ACCESSIBLE FIXTURES WHERE NO BASE CABINET OCCURS BENEATH A LAVATORY OR SINK.
8. PROPERLY CAULK ALL PLUMBING PENETRATIONS AND GAPS THROUGH WALLS AND SLAB. PROVIDE FIRE STOP SEALANT AT ANY RATED WALLS.

DOMESTIC WATER:

1. SUBMIT DOMESTIC WATER SUPPLY PIPING DIAGRAM PRIOR TO INSTALLATION OF ANY PIPE.
2. PROVIDE 1" WATER LINE.
3. PROVIDE AN ACCESSIBLE MASTER SHUT-OFF VALVE LOCATED BY THE WATER HEATER OR WATER SOFTENER.
4. FOR DOMESTIC WATER PIPING ABOVE GRADE OR WITHIN BOUNDARIES OF FOUNDATION BELOW GRADE, USE COPPER, PVC (COLD), CPVC (HOT), OR PEX (POLYETHYLENE CROSS-LINKED) TUBING AND FITTINGS.
5. PROVIDE INDIVIDUAL WATER SUPPLY SHUT-OFF VALVES FOR ALL PLUMBING FIXTURES.
6. ADJUST SUPPLY LINE WALL PENETRATION HEIGHTS AS NEEDED TO AVOID CONFLICTS BETWEEN FLUSH VALVES AND GRAB BAR MOUNTING HEIGHTS. GRAB BAR HEIGHTS TAKE PRIORITY.
7. PROVIDE AIR CHAMBER, FULL PIPE SIZE, AT EACH HOT AND COLD WATER CONNECTION, 18" LONG.
8. PRESSURE TEST ALL WATER LINES BEFORE INSTALLING GYPSUM BOARD.

WASTE PIPING:

1. FOR ALL SANITARY WASTE PIPING, USE SCHEDULE 40 PVC OR HUBLESS CAST IRON.
2. PROVIDE CODE APPROVED TRAPS FOR ALL PLUMBING FIXTURES.
3. FOR SINGLE RUN-OUTS TO PLUMBING FIXTURES, USE SAME SIZE AS ON THE PLUMBING FIXTURE SCHEDULE UNLESS OTHERWISE NOTED.
4. PROVIDE TRAPS WITH WATER SEALS FOR ALL FIXTURE DRAINS EXCEPT FIXTURES WHICH HAVE INTEGRAL TRAPS (WATER CLOSETS). DOUBLE-TRAPPING ANY FIXTURE IS PROHIBITED BY CODE.
5. NOT USED
6. SET FLOOR DRAINS PRIOR TO POURING FLOOR SLAB.

WASTE VENTING:

1. FOR ALL SANITARY VENT PIPING, USE SCHEDULE 40 PVC OR HUBLESS CAST IRON.
2. INDIVIDUALLY VENT ALL PLUMBING FIXTURES; GANG VENTING OF INDIVIDUAL UNIT VENTS INTO ONE COMMON VENT WILL NOT BE ACCEPTED.
3. PLACE VENTS ON BACK SIDE OF ROOFS AND PAINT BLACK.

PLUMBING FIXTURES AND PLUMBED APPLIANCES:

1. FOR ALL PLUMBING FIXTURES, INSTALL WITH APPROVED BACKFLOW PREVENTION DEVICES.
2. DO NOT CAULK TOILET BASE.
3. FOR ALL TOILETS, PROVIDE HANDLES ON OPEN SIDE (SIDE OPPOSITE WALL NEAREST SIDE OF TOILET) OF THE FIXTURE.
4. USE LOW FLOW DEVICES FOR LAVATORY AND SINK FAUCETS.

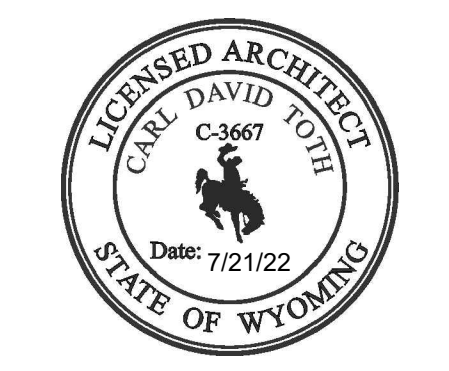
SPECIFIC NOTES:

- PO1: CAP EXISTING SANITARY RISER BELOW FLOOR SLAB.
- PO2: CONNECT TO EXISTING SANITARY WITH ELBOW IN DIRECTION OF FLOW.
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DRAWING SCALE: SEE DRAWING

REVISIONS

MARK	DATE	INIT.	DESCRIPTION

PROJECT TITLE

CIAD - WYOMING
5 NEX PERCE DRIVE
CODY, WYOMING 82414

SHEET TITLE
PLUMB - ISO

SHEET NUMBER

P121

SHEET: OF:

FILE: S:\BRANDON\TERRY LONG\WYOMING CAD\CAD - WYOMING\SHEETS\22075-PLUMB - ISO - DOM. WATER.DWG
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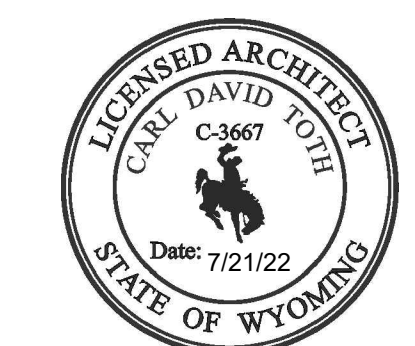
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PROJECT TITLE

B

CIAD - WYOMING
 5 NEX PERCE DRIVE
 CODY, WYOMING 82414

SHEET TITLE
 ELEC - PLAN -
 POWER

SHEET NUMBER

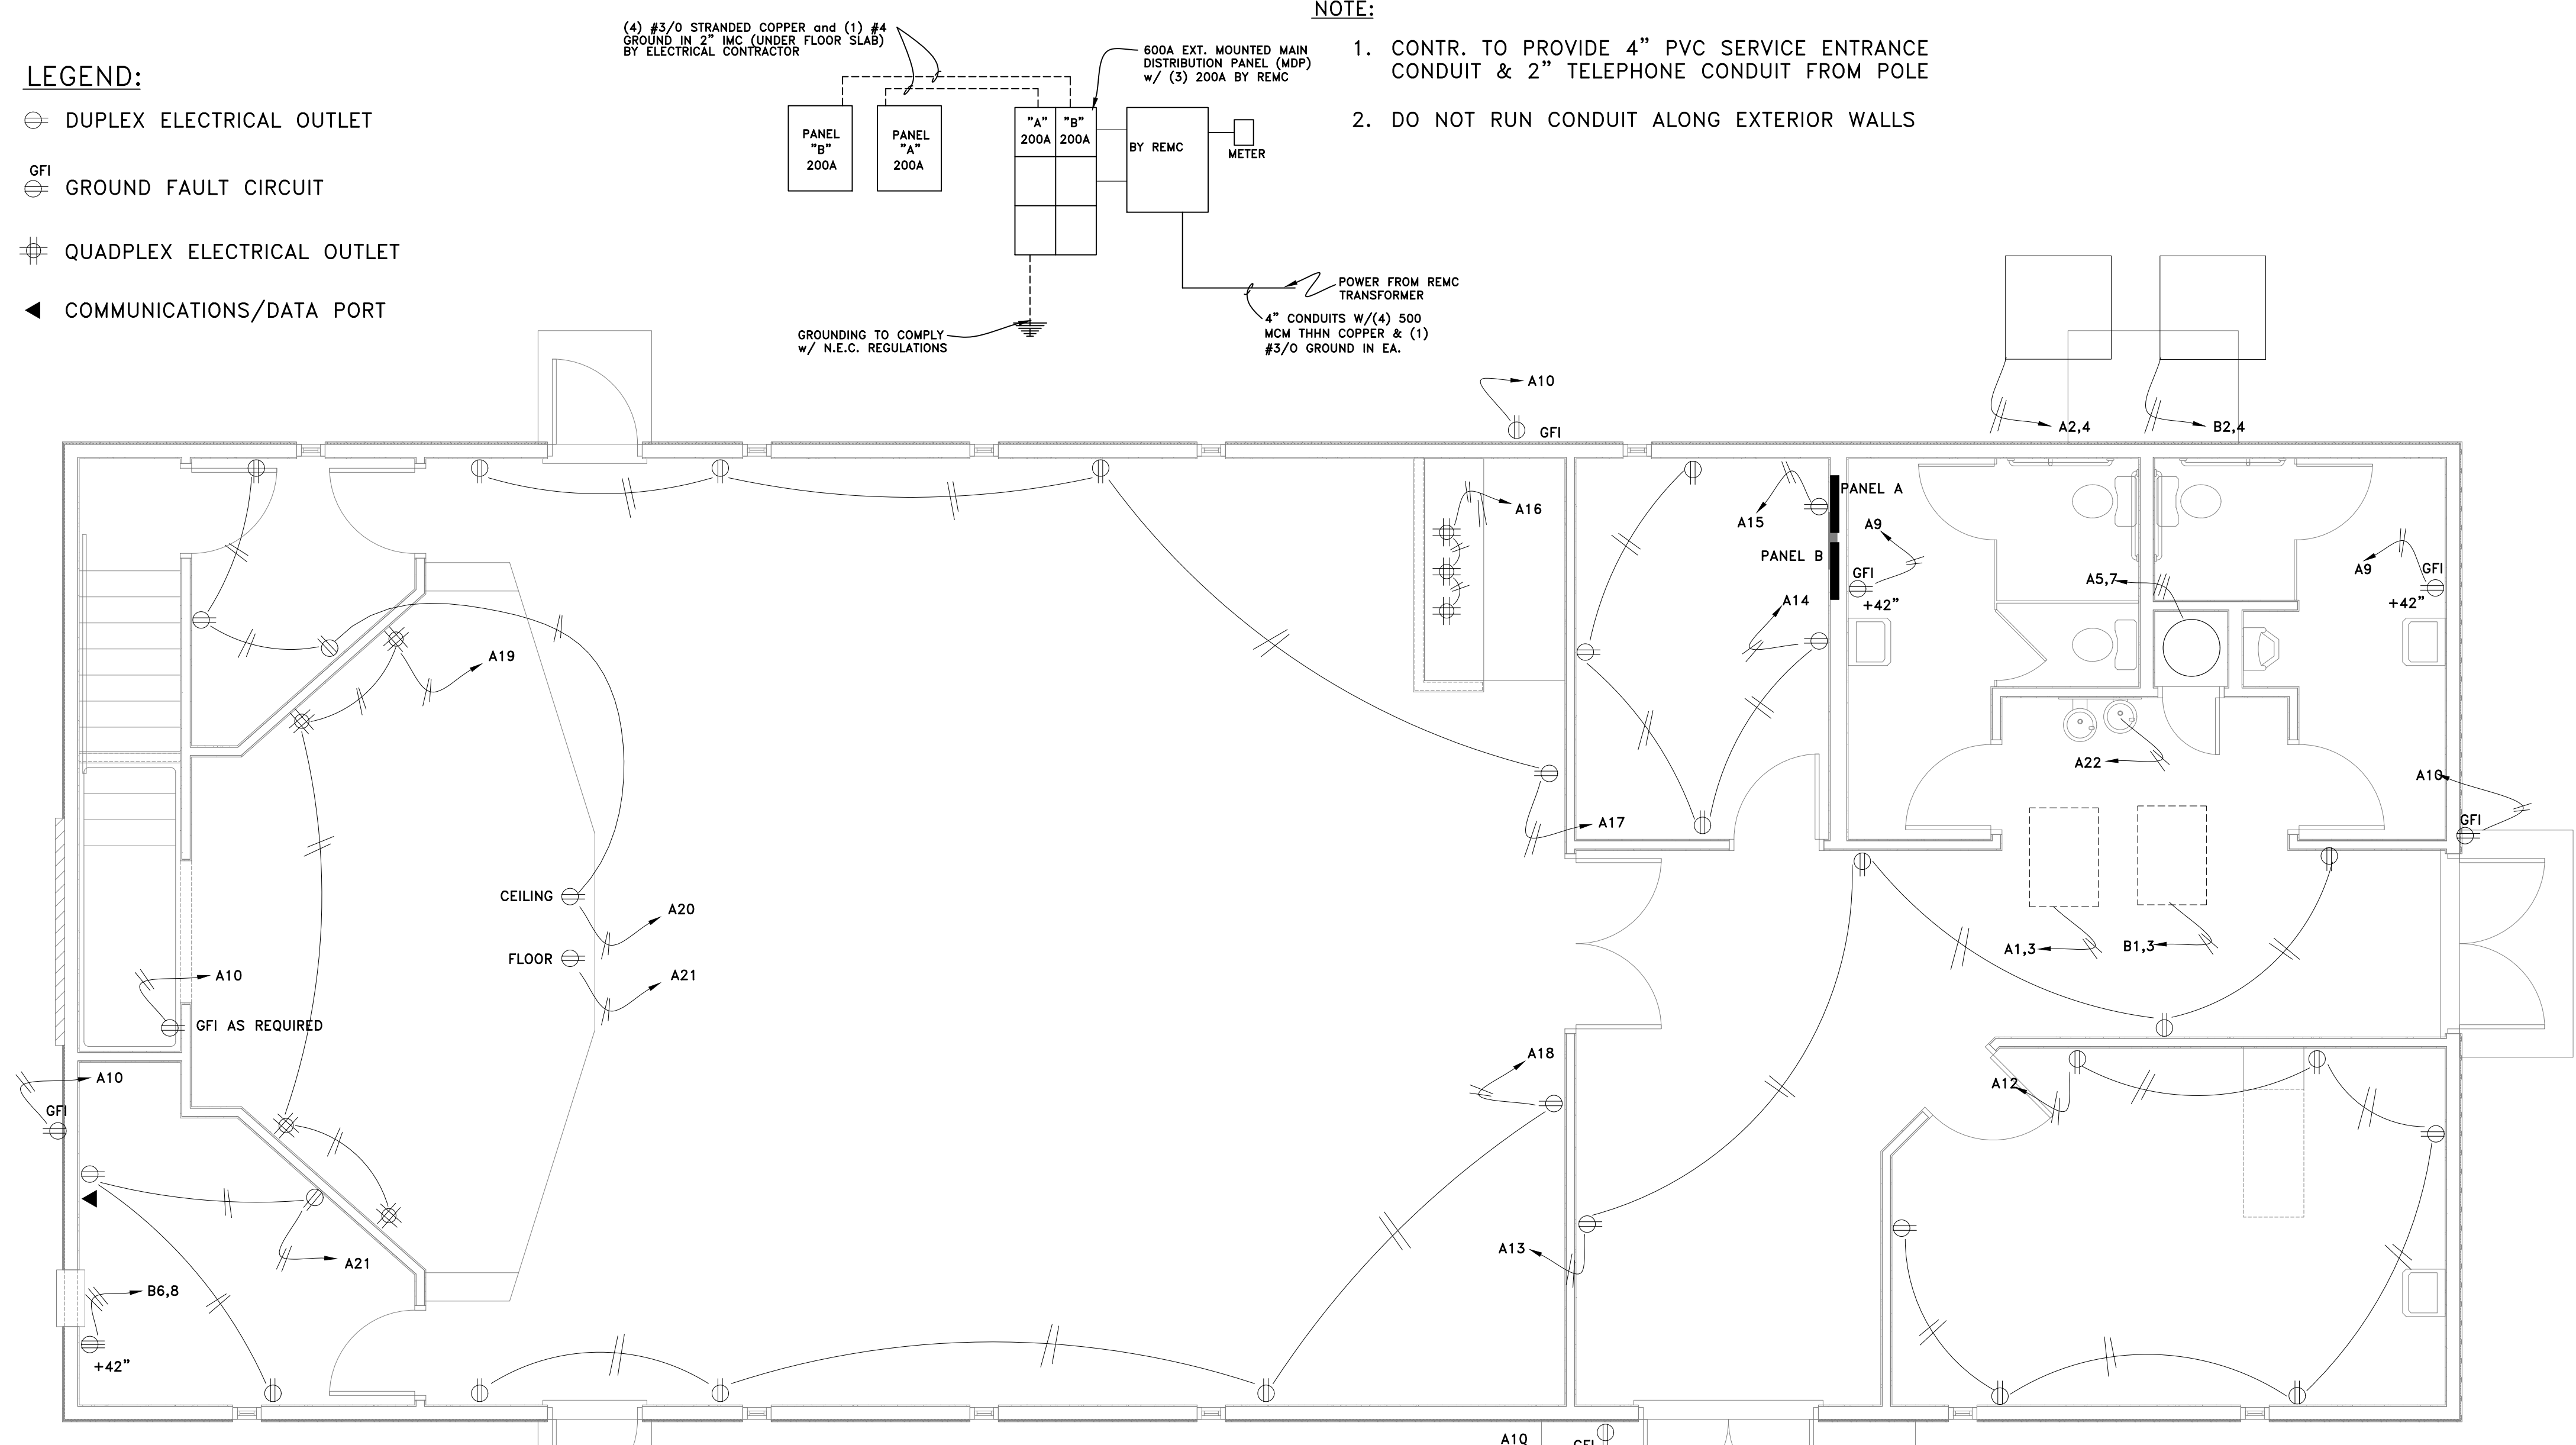
E111

SHEET: OF:

- LEGEND:**
- ⊕ DUPLEX ELECTRICAL OUTLET
 - ⊕ GFI GROUND FAULT CIRCUIT
 - ⊕ QUADPLEX ELECTRICAL OUTLET
 - ◀ COMMUNICATIONS/DATA PORT

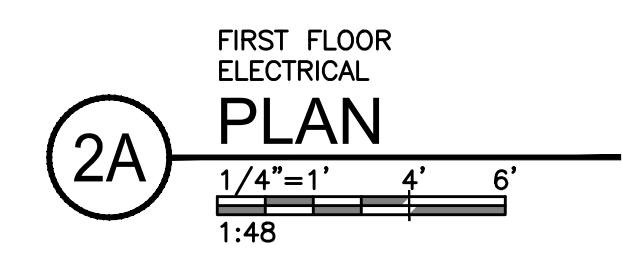
NOTE:
 (4) #3/0 STRANDED COPPER and (1) #4 GROUND IN 2" IMC (UNDER FLOOR SLAB) BY ELECTRICAL CONTRACTOR

- NOTE:**
1. CONTR. TO PROVIDE 4" PVC SERVICE ENTRANCE CONDUIT & 2" TELEPHONE CONDUIT FROM POLE
 2. DO NOT RUN CONDUIT ALONG EXTERIOR WALLS



NOTE:
 ELECTRICAL CONTRACTOR TO BE RESPONSIBLE FOR BALANCING ALL PANEL LOADS.

- ELECTRICAL NOTES**
1. ELECTRICAL INSTALLATION SHALL MEET ALL FEDERAL, STATE AND LOCAL CODES AND COMPLY WITH THE LATEST NATIONAL ELECTRICAL CODE.
 2. RESTROOM AND EXTERIOR CONVENIENCE OUTLETS, AND OUTLETS AT SINKS SHALL BE G.F.I.
 3. WIRING SHALL BE #12 STRANDED WIRE, MINIMUM.
 4. ALL WIRING SHALL BE RUN IN METAL CONDUIT. NM, NMS OR NMC CABLE MAY BE USED FOR DISTRIBUTION FROM PANEL IN ACCORDANCE WITH 675 IAC 17-1-1.8-15 FOR CIRCUITS UP TO 30 AMP.
 5. RECEPTACLES ARE TO BE 18" ABOVE FINISHED FLOOR, UNLESS NOTED OTHERWISE. LOCATE ALL SWITCHES AT 42" A.F.F. UNLESS OTHERWISE NOTED.
 6. CONTRACTOR SHALL MAINTAIN 3'-0" (MIN.) CLEARANCE IN FRONT OF PANEL BOARDS PER N.E.C. 110-16.



6

5

4

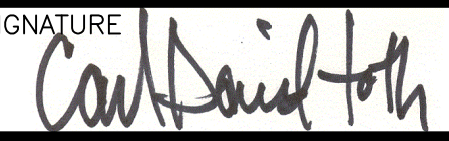
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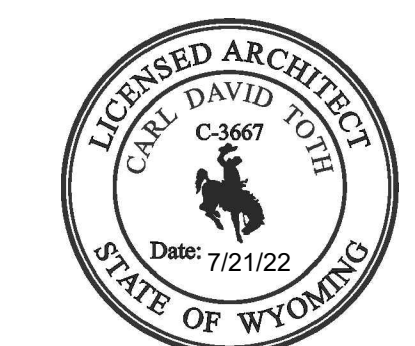
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
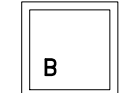

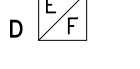


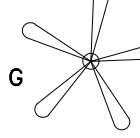




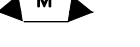

SHEET TITLE
 ELEC - PLAN -
 LIGHTING

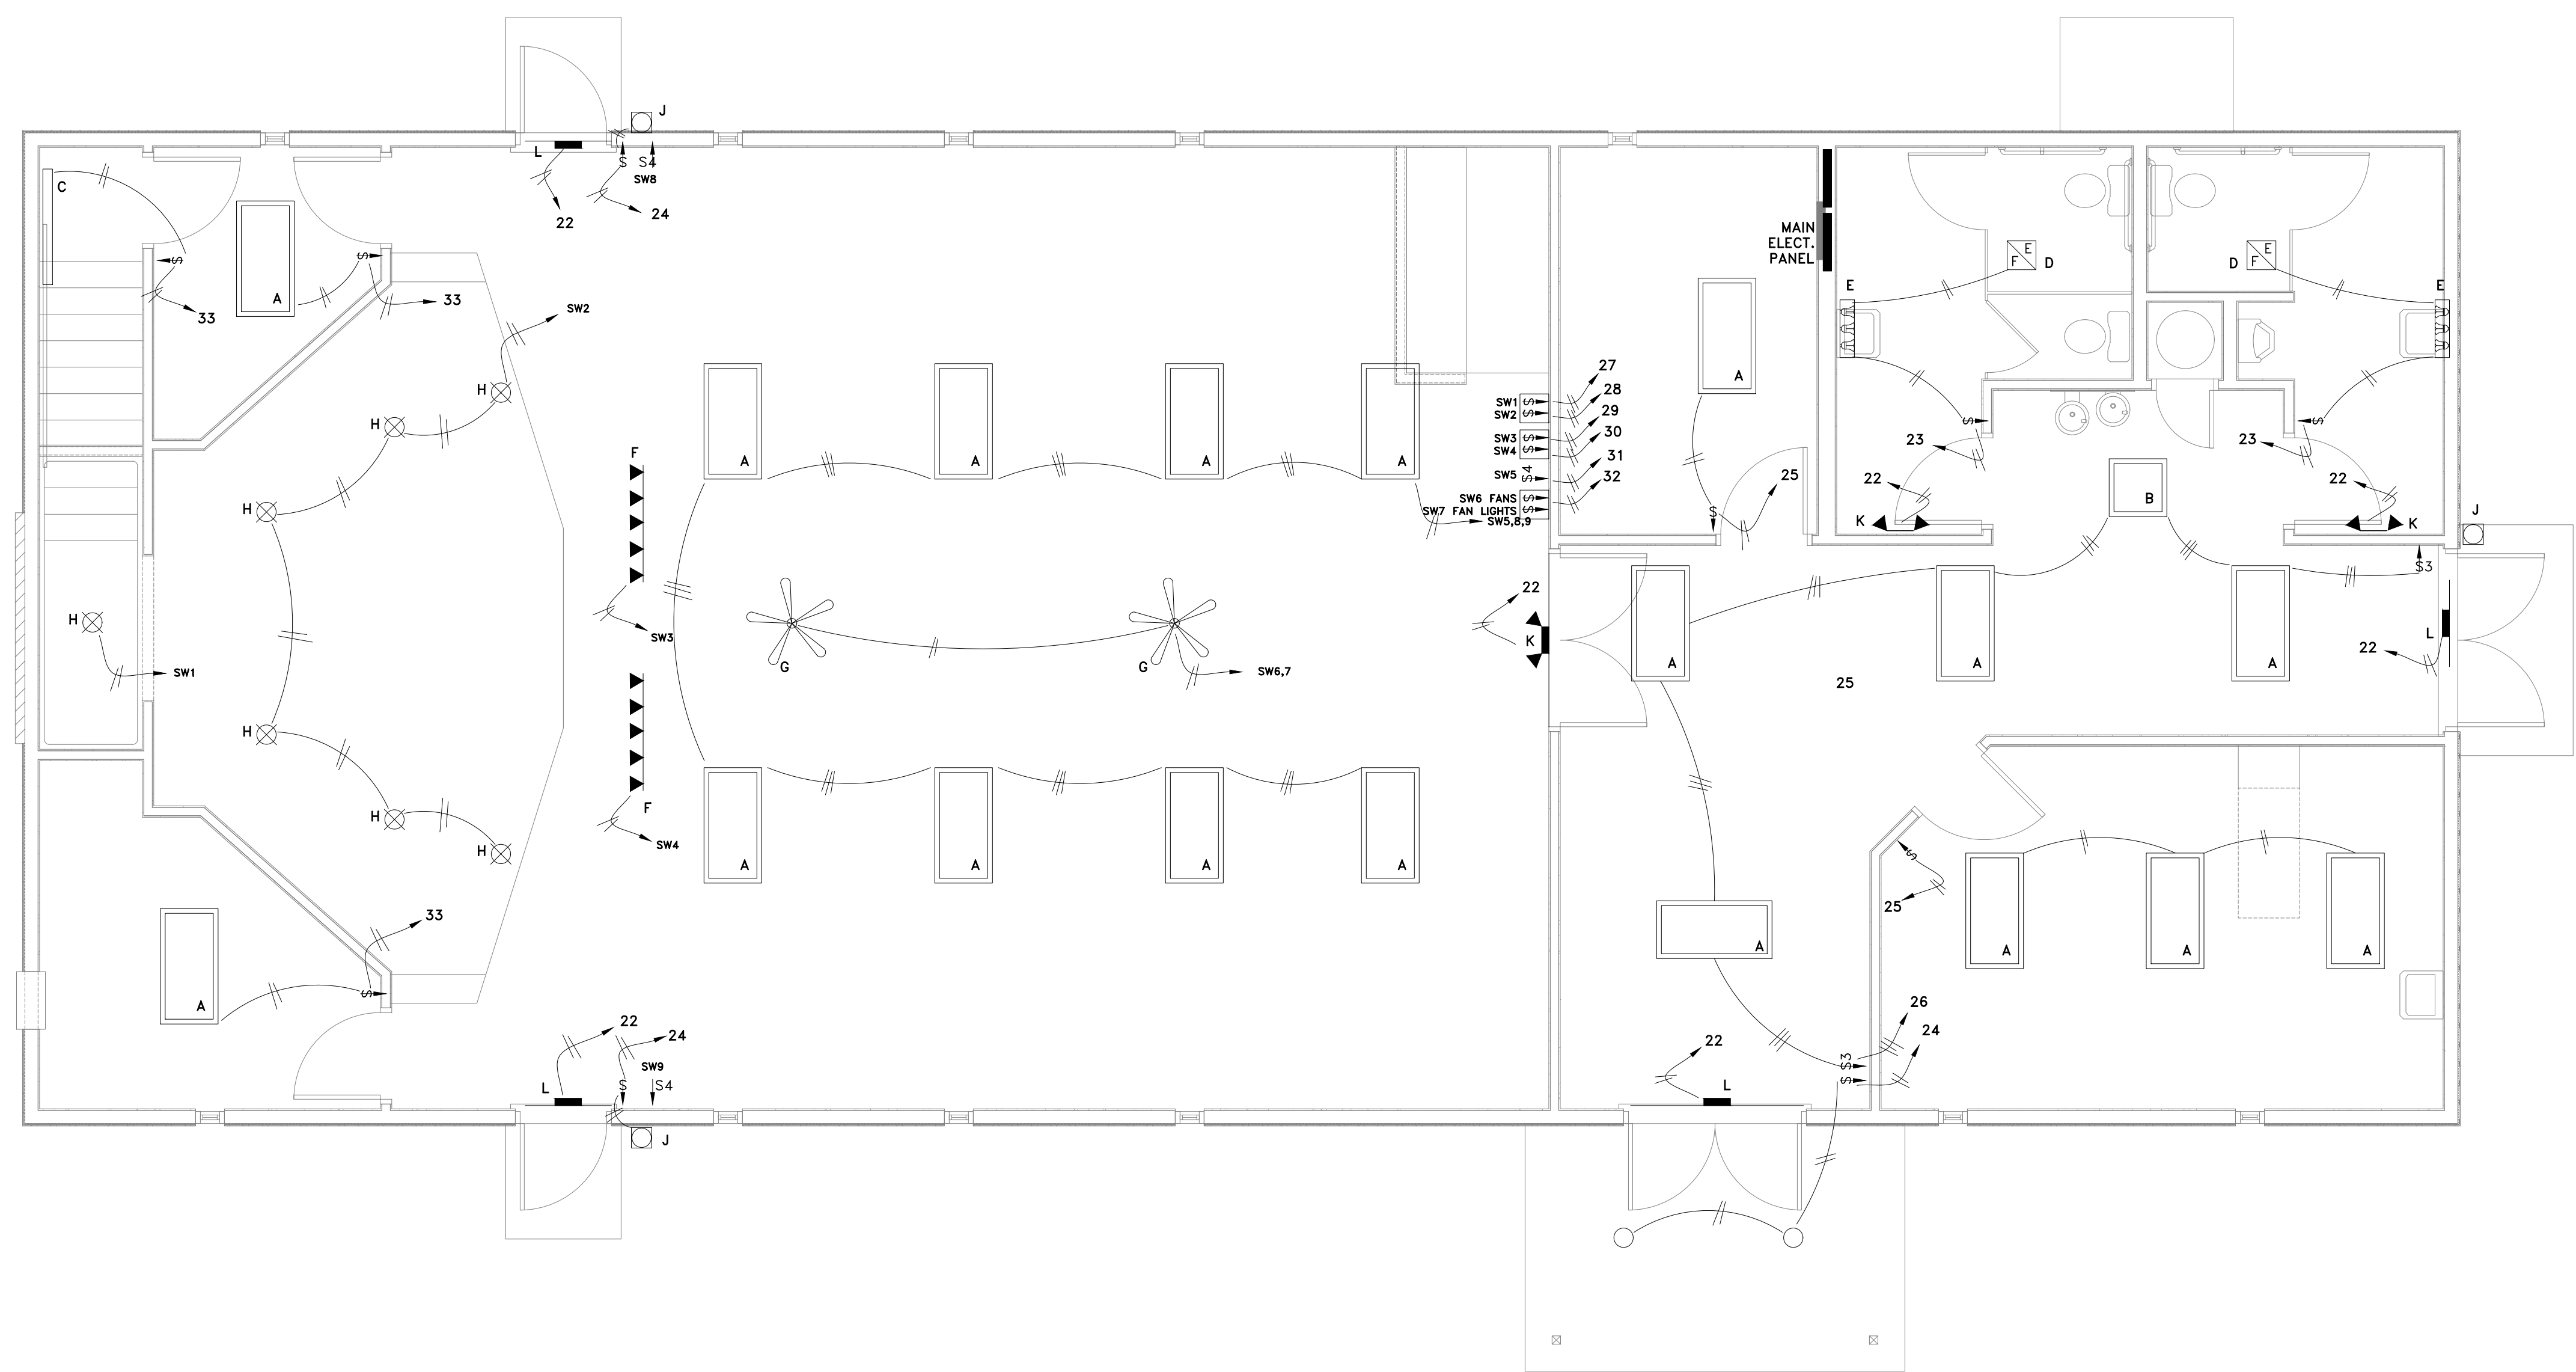
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LIGHTING LEGEND:

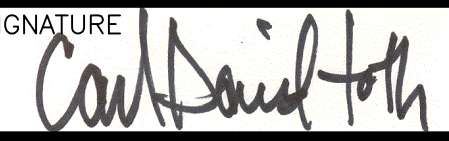
-  2x4 CEILING MOUNTED LAMP - LED
-  2x2 CEILING MOUNTED LAMP - LED
-  WALL MOUNTED 4' LED
-  EXHAUST FAN AND LIGHT
-  WALL MOUNTED BATHROOM FIXTURE
-  TRACK LIGHTING
-  CEILING FAN w/ LIGHT
-  LED CAN LIGHT w/ WHITE TRIM
-  OUTDOOR WALL SCNCE
-  EXIT/EMERGENCY LIGHTING
-  BACKLIT EXIT SIGN
-  EMERGENCY LIGHTING
-  EXTERIOR RATED RECESSED LIGHTING

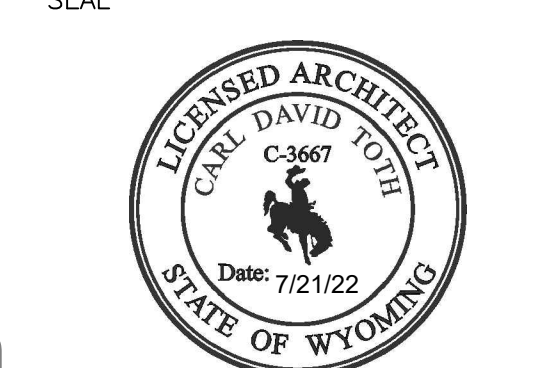


2A LIGHTING PLAN
 1/4"=1' 4' 6"
 1:48

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SHEET TITLE
 ELEC - SCHED -
 PANEL

SHEET NUMBER

E611

SHEET: OF:

